Proposed Warehouse Building Amherst, New York

AGENCIES

ENGINEERING DEPARTMENT

NAME/TITLE: JEFFERY BURROUGHS, P.E. - TOWN ENGINEER TOWN OF AMHERST ENGINEERING DEPARTMENT COMPANY/DEPT: 1100 NORTH FOREST ROAD

WILLIAMSVILLE, NEW YORK 14221

TELEPHONE 716-631-7154

PLANNING & ZONING DEPARTMENT

DANIEL HOWARD - PLANNING DIRECTOR TOWN OF AMHERST PLANNING DEPARTMENT COMPANY/DEPT:

5583 MAIN STREET

WILLIAMSVILLE, NEW YORK 14221

TELEPHONE 716-631-7051

BUILDING DEPT.

NAME/TITLE: BERKE, MARK S. - COMMISSIONER OF BUILDING

COMPANY/DEPT.: TOWN OF AMHERST BUILDING DEPT.

5583 MAIN ST. ADDRESS:

AMHERST, NEW YORK 14221

716-631-7080 **TELEPHONE**

<u>ECDOH</u> NAME/TITLE:

COMPANY/DEPT:. ERIE COUNTY DEPARTMENT OF HEALTH

503 KENSINGTON AVE ADDRESS: BUFFALO, NEW YORK 14214

716-961-6854 **TELEPHONE**

<u>NYSDEC</u>

NAME/TITLE: COMPANY/DEPT:

NEW YORK STATE DEPT. OF ENVIRONMENTAL

CONSERVATION ADDRESS: 700 DELAWARE AVE.

BUFFALO, NEW YORK 14209

TELEPHONE 716-851-7070

UTILITIES

NATURAL GAS

COMPANY/DEPT:.

NATIONAL FUEL GAS CORP. 6363 MAIN STREET WILLIAMSVILLE, NEW YORK 14221

716-857-7000 TELEPHONE

TELEPHONE COMPANY

COMPANY/DEPT:

VERIZON 65 FRANKLIN STREET BUFFALO, NEW YORK 14203

TELEPHONE 716-840-8748

CABLE COMPANY

COMPANY/DEPT: ADDRESS:

TIME WARNER 789 CHURCH ROAD WEST SENECA, NEW YORK

TELEPHONE 716-558-8615

ELECTRIC COMPANY COMPANY/DEPT:

ADDRESS:

NATIONAL GRID 144 KENSINGTON AVENUE BUFFALO, NEW YORK 14214

TELEPHONE 716-236-2738

<u>WATER</u>

COMPANY/DEPT:. ADDRESS:

ERIE COUNTY WATER AUTHORITY 3030 UNION ROAD CHEEKTOWAGA, NEW YORK 14227

716-684-1510 TELEPHONE

DIG SAFELY NEW YORK

1-800-962-7962 TELEPHONE

DESIGN CONSULTANTS

PROJECT SURVEYOR

NAME/TITLE: COMPANY/DEPT:. ADDRESS:

GPI ENGINEERING, LANDSCAPE, ARCHITECTURE & SURVEYING, LLP 4950 GENESEE STREET, SUITE 100

BUFFALO, NEW YORK 14225

716-633-4844 TELEPHONE


OWNER/DEVELOPER

NAME: STEPHENS PLUMBING **ADDRESS**

5500 MILLERSPORT HIGHWAY EAST AMHERST, NY 14051

CONTACT: **KEVIN STEPHENS**

TELEPHONE 716-512-9451

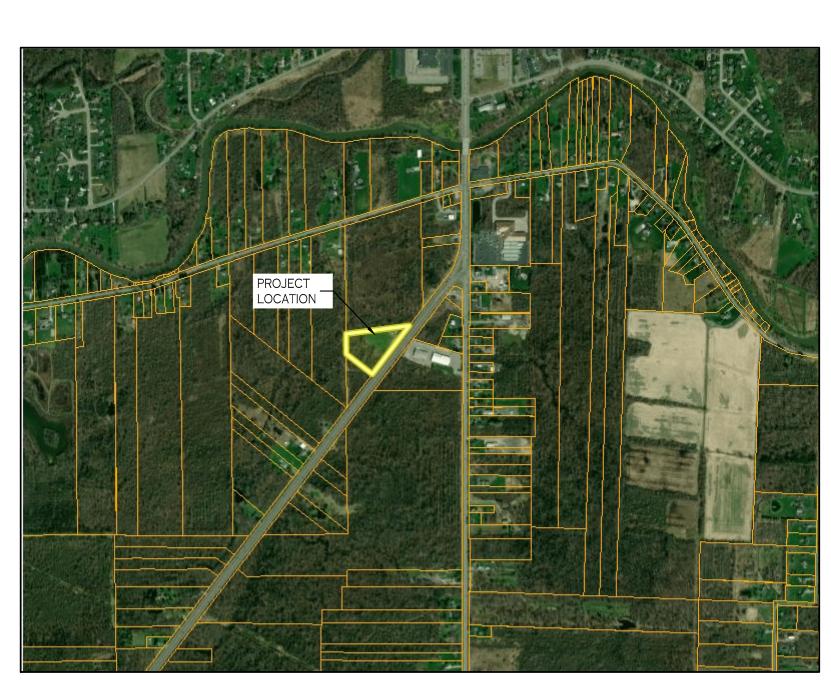



CARMINAWOOD DESIGN

November 2024 Rev. MARCH 2025

EROSION CONTROL DETAILS SITE PLAN SITE DETAILS GRADING PLAN STORM DRAINAGE PLAN BASIN DETAILS STORM DRAINAGE DETAILS UTILITY PLAN UTILITY DETAILS UTILITY DETAILS UTILITY DETAILS UTILITY DETAILS LANDSCAPE PLAN LIGHTING DETAILS

Date

03/21/2025

REVISIONS: No. Description


1\ Rev. Per Town Comments


EROSION CONTROL PLAN

LAND SURVEY (PREPARED BY GPI ENGINEERING)

DRAWING TITLE

Proposed Warehouse Building Amherst, New York

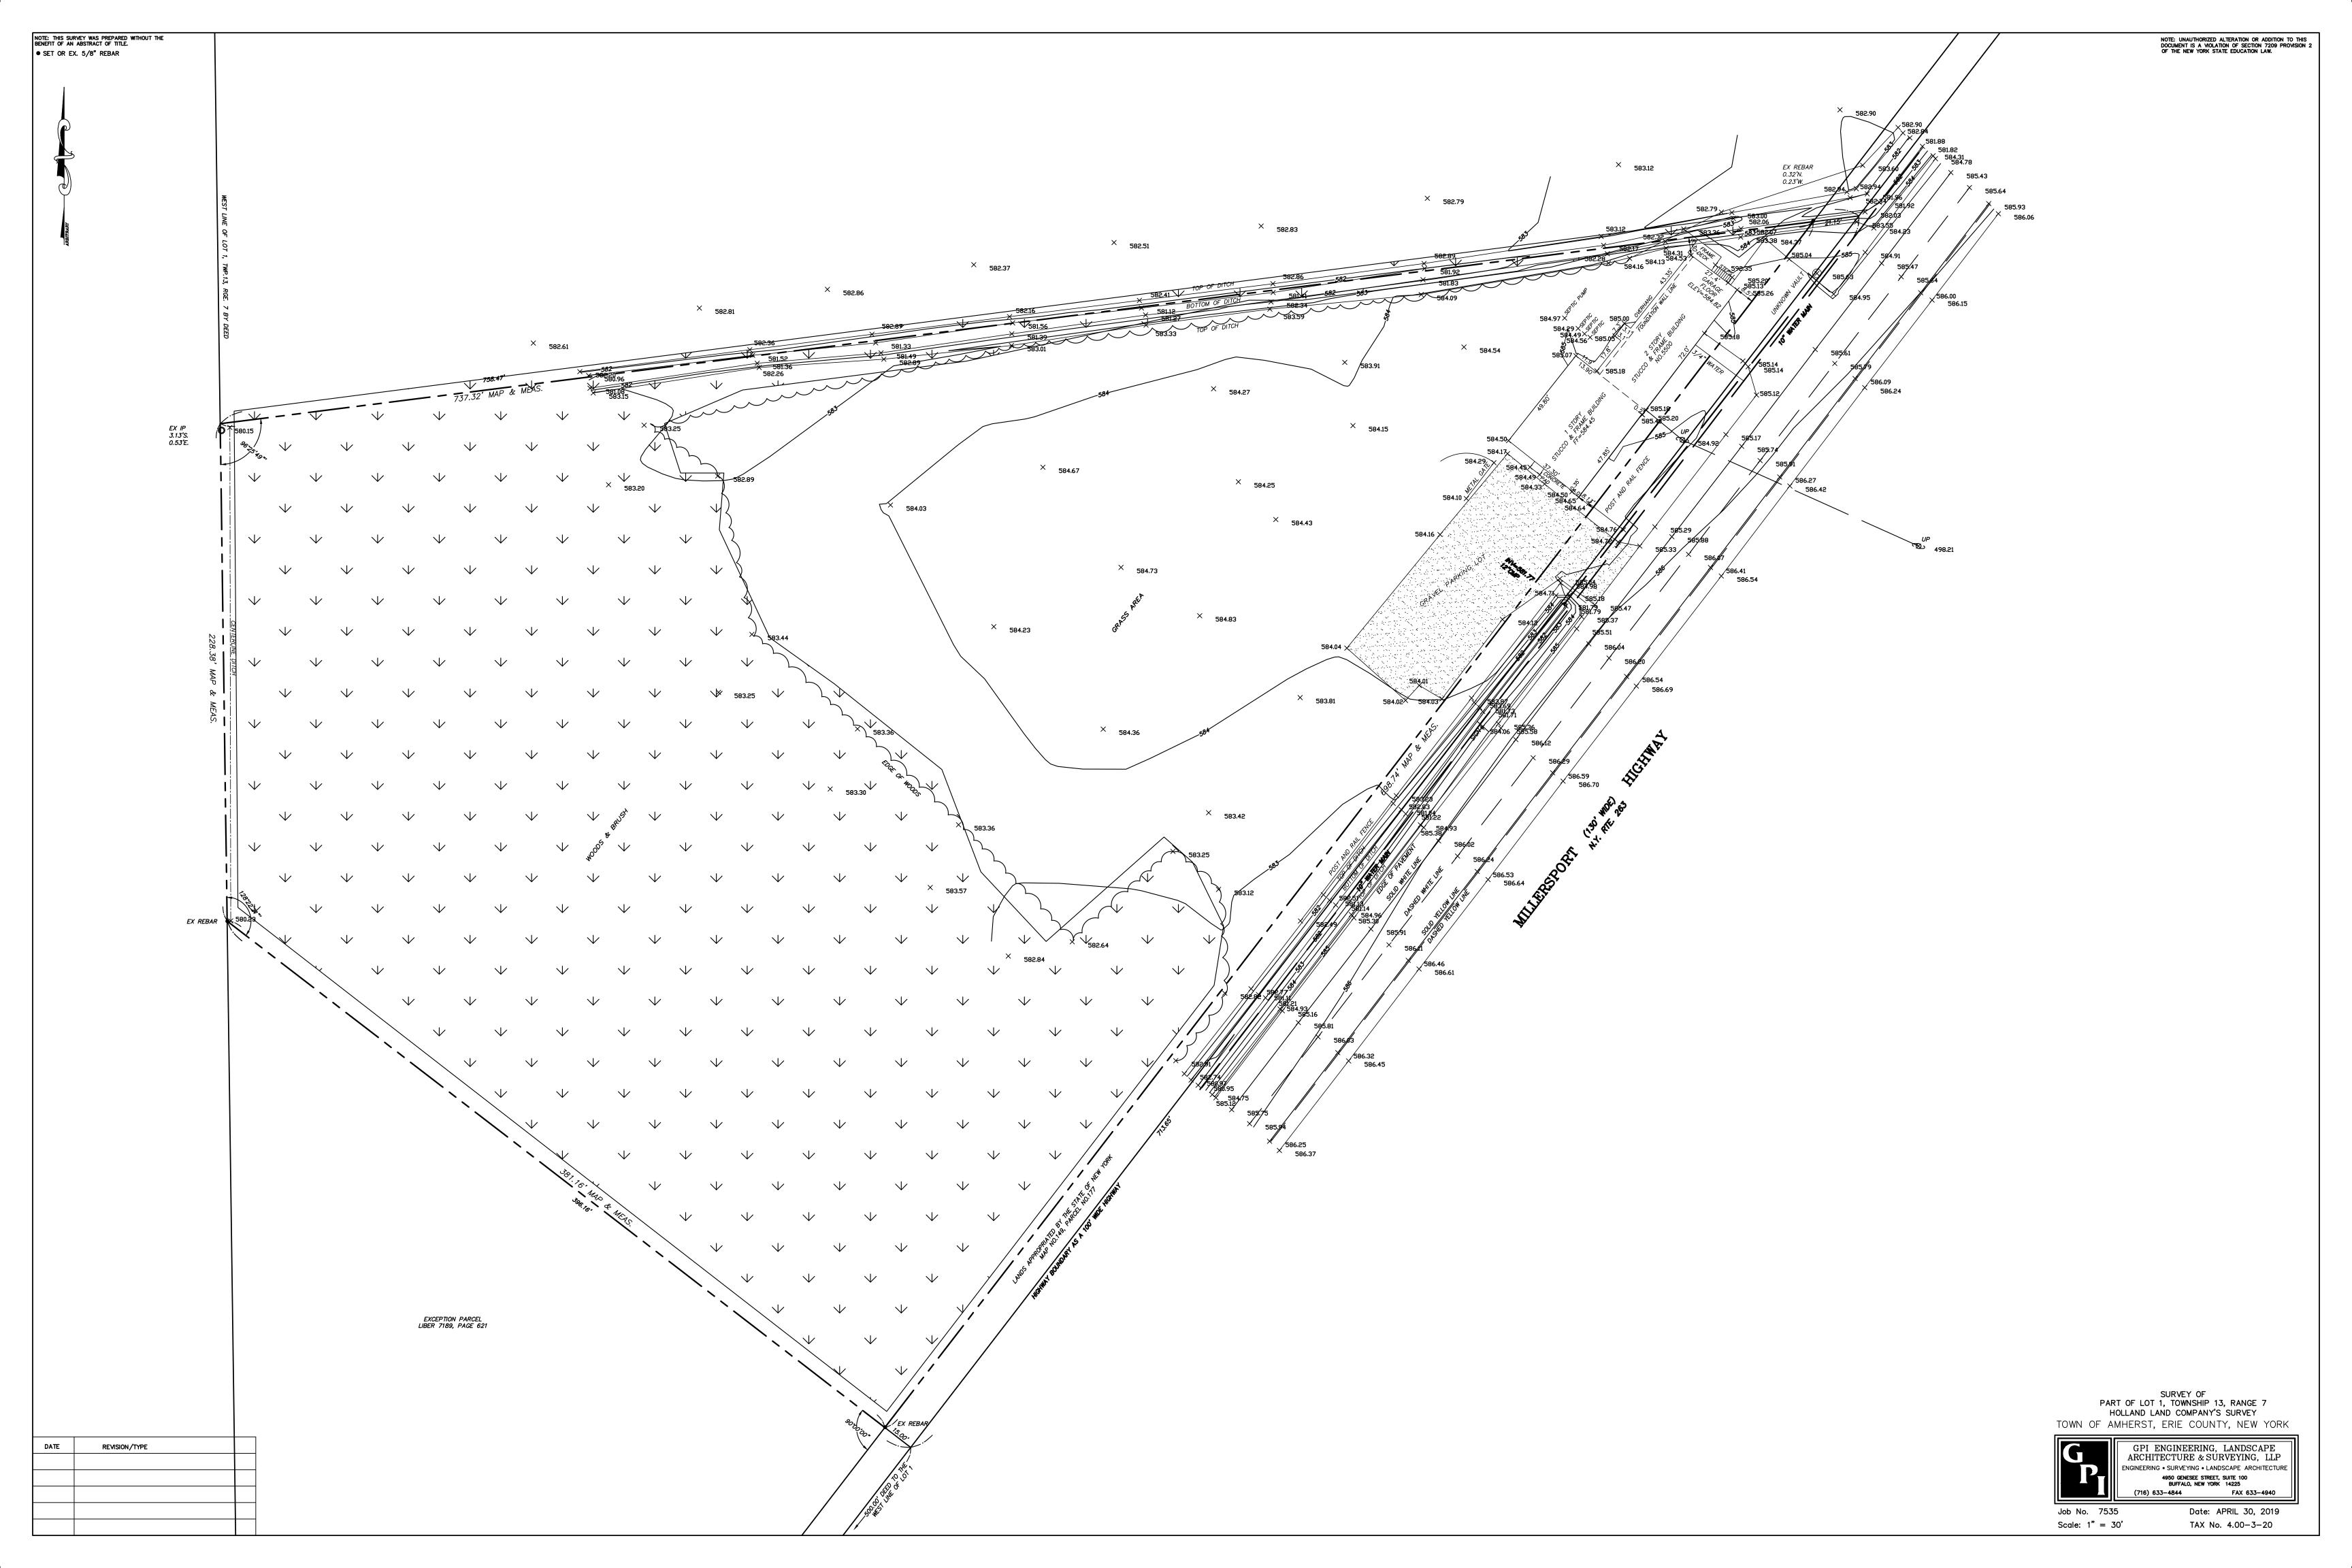

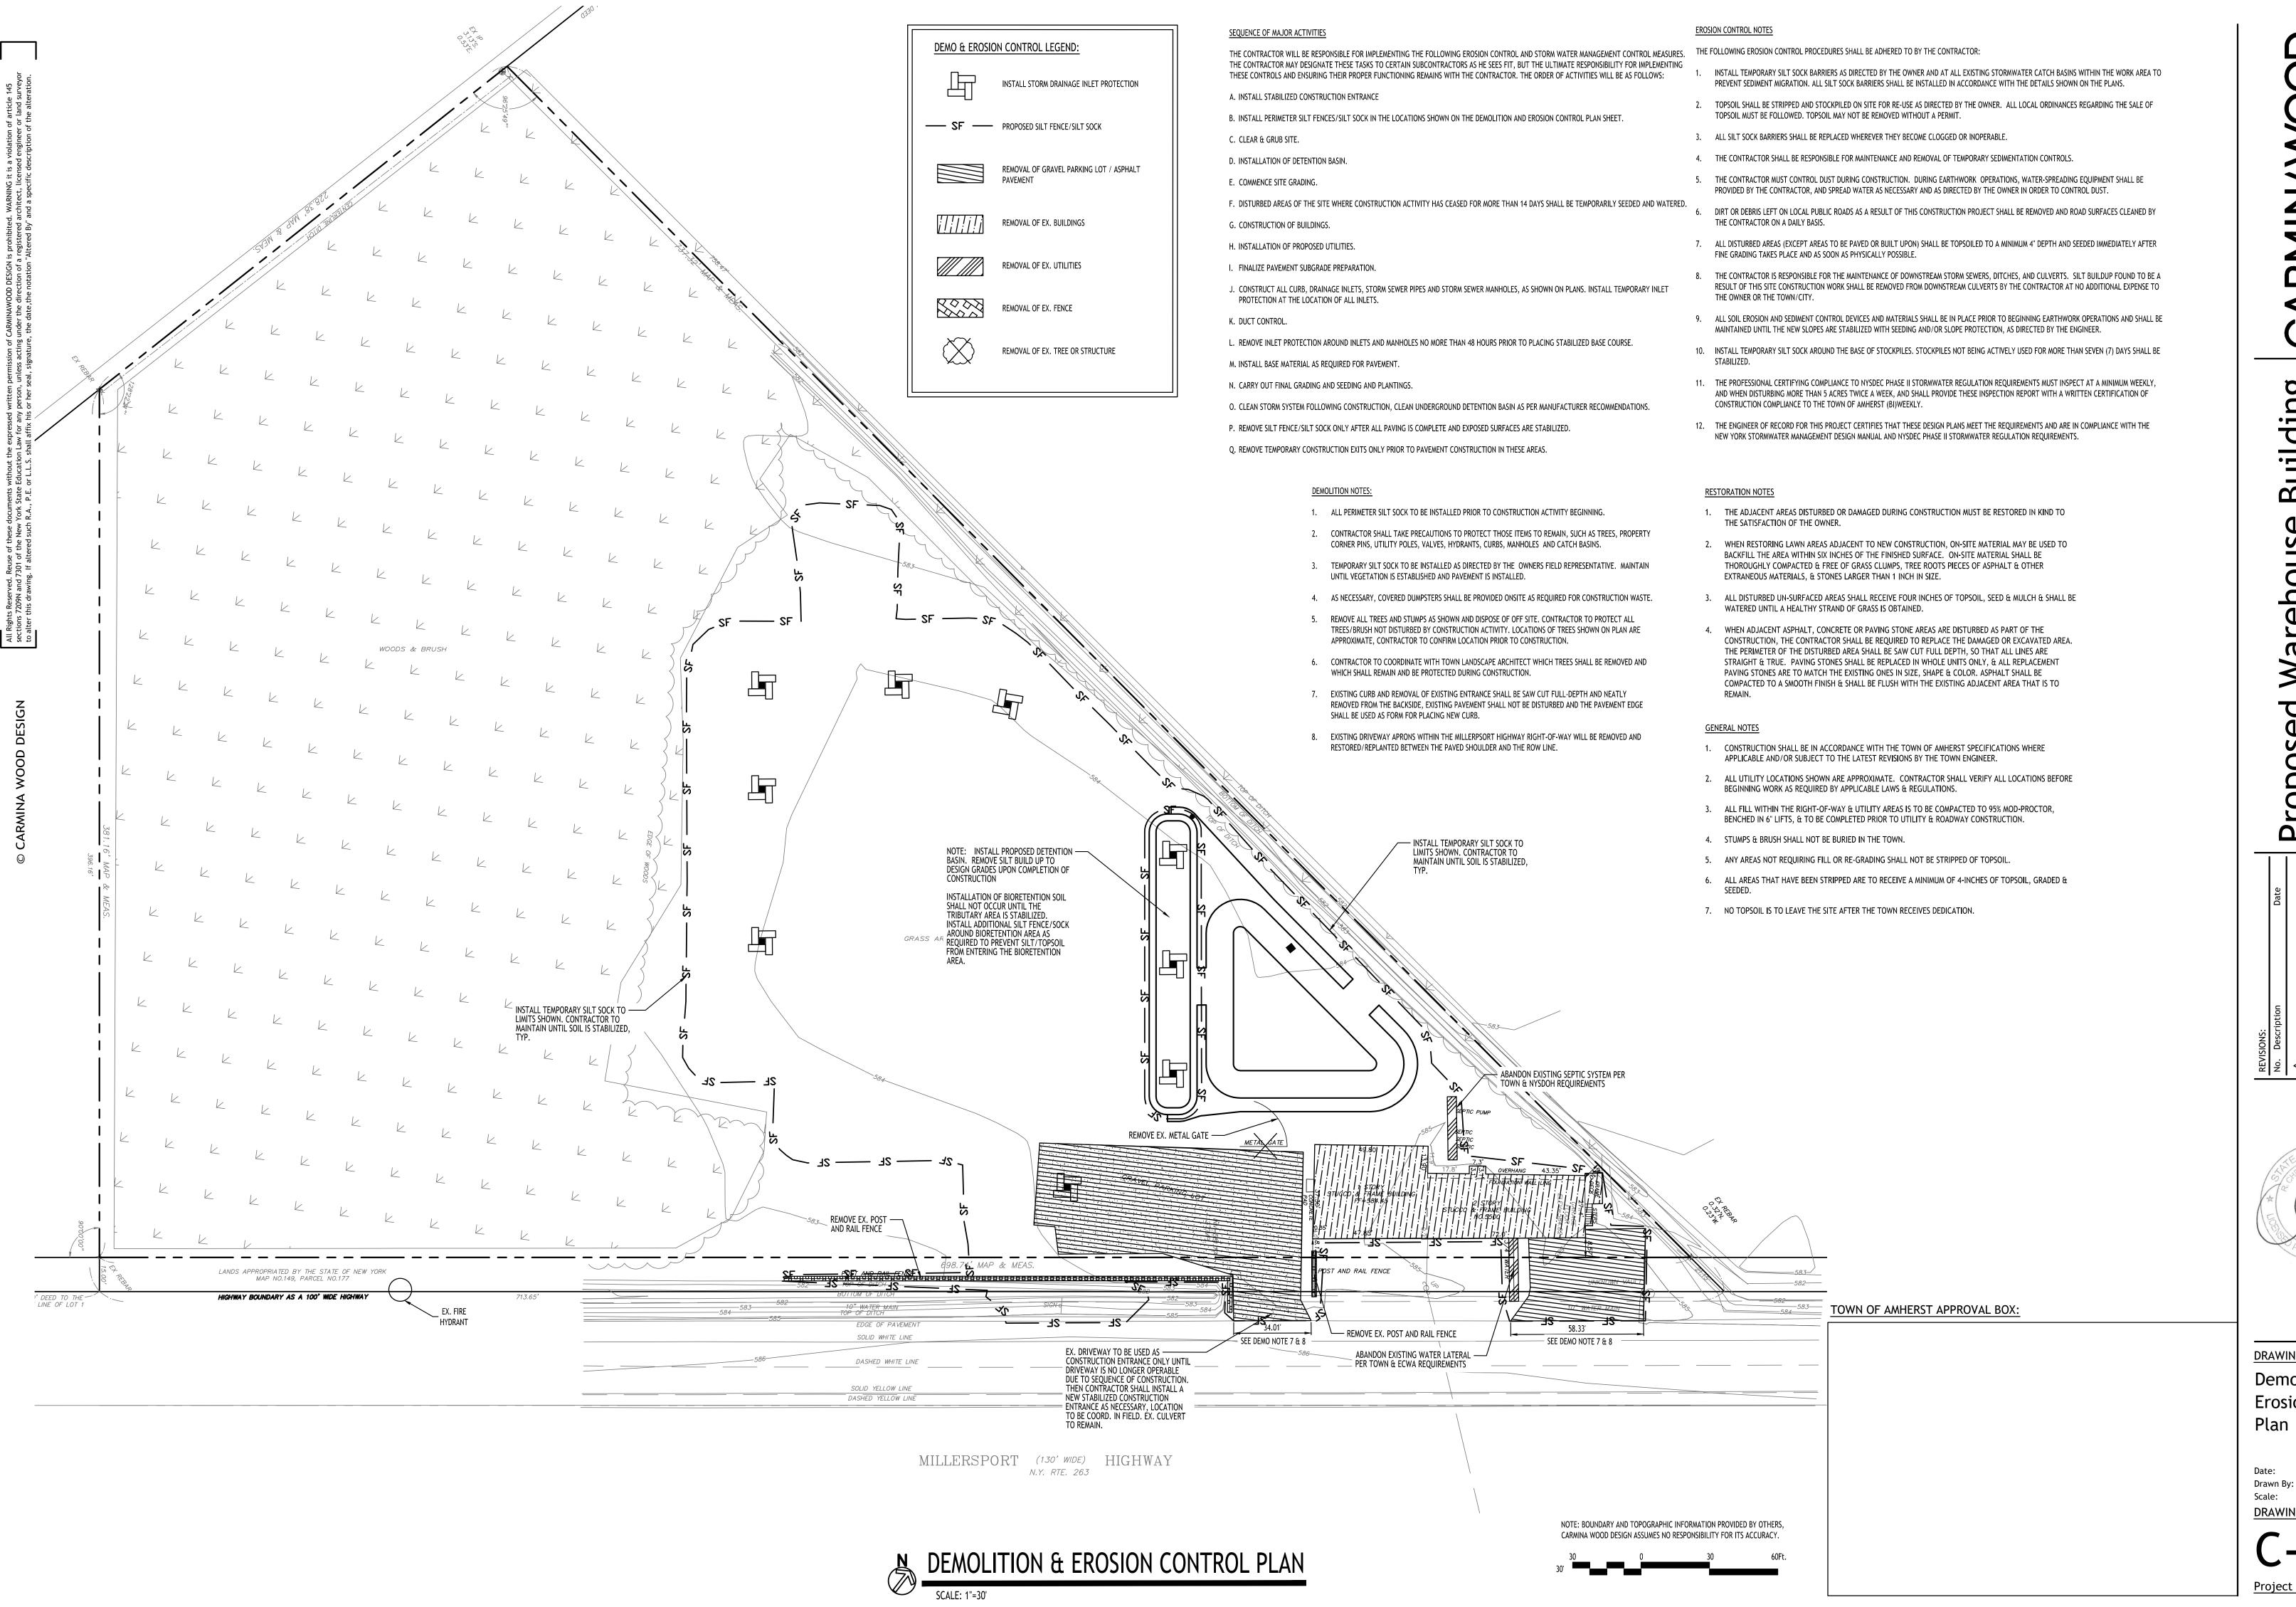


 $\mathbf{\Omega}$

DRAWING NAME: Demolition & **Erosion Control**

As Noted DRAWING NO.

11/19/24

C. Wood

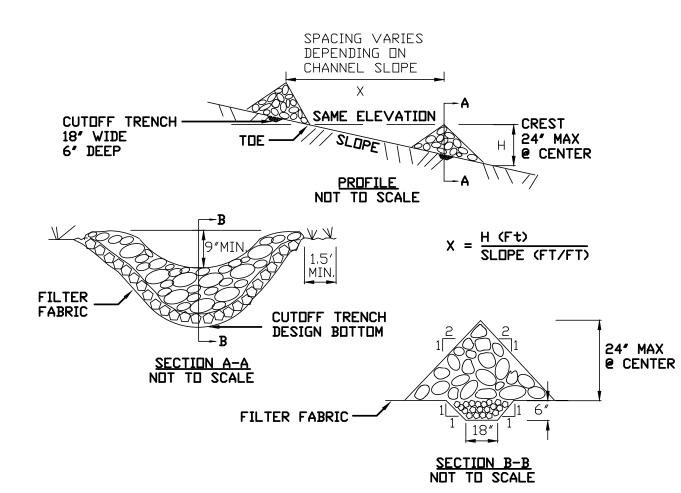


CONSTRUCTION SPECIFICATIONS

- 1. STONE WILL BE PLACED ON A FILTER FABRIC FOUNDATION TO THE LINES, GRADES AND LOCATIONS SHOWN IN THE PLAN.
- 2. SET SPACING OF CHECK DAMS TO ASSUME THAT THE ELEVATIONS OF THE CREST OF THE DOWNSTREAM DAM IS AT THE SAME ELEVATION OF THE TOE OF THE
- 3. EXTEND THE STONE A MINIMUM OF 1.5 FEET BEYOND THE DITCH BANKS TO PREVENT CUTTING AROUND THE DAM.
- 4. PROTECT THE CHANNEL DOWNSTREAM OF THE LOWEST CHECK DAM FROM SCOUR
- AND EROSION WITH STONE OR LINER AS APPROPRIATE. 5. ENSURE THAT CHANNEL APPURTENANCES SUCH AS CULVERT ENTRANCES BELOW CHECK DAMS ARE NOT SUBJECT TO DAMAGE OR BLOCKAGE FROM DISPLACED STONE. MAXIMUM DRAINAGE AREA 2 ACRES.

- UNDISTURBED GROUND

— POSTS SHALL BE A MINIMUM OF 16"

BELOW THE EXISTING GRADE

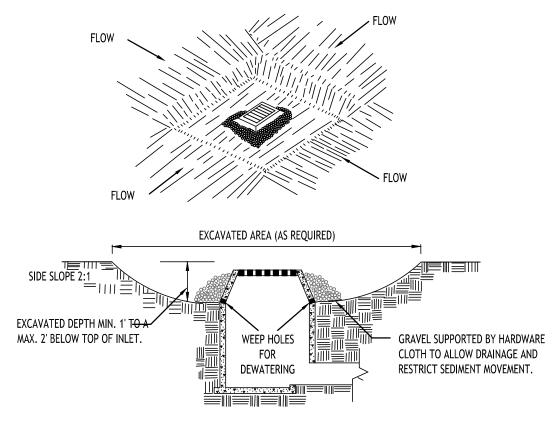

CONSTRUCTION SPECIFICATIONS

- 1. CLEAR THE AREA OF ALL DEBRIS THAT WILL HINDER EXCAVATION.
- 2. GRADE APPROACH TO THE INLET UNIFORMLY AROUND THE BASIN.
- 3. WEEP HOLES SHALL BE PROTECTED BY GRAVEL
- 4. UPON STABILIZATION OF CONTRIBUTING DRAINAGE AREA, SEAL WEEP HOLES, FILL BASIN WITH STABLE SOIL TO FINAL GRADE, COMPACT IT PROPERLY AND STABILIZE WITH PERMANENT SEEDING. MAXIMUM DRAINAGE AREA 1 ACRE



INLET PROTECTION DETAIL 2

NOT TO SCALE


CONSTRUCTION SPECIFICATIONS

1. FILTER FABRIC SHALL HAVE AN EOS OF 40-85. BURLAP MAY BE USED FOR SHORT TERM APPLICATIONS.

FEET MAY BE BRIDGED WITH THE USE OF WIRE MESH BEHIND THE FILTER FABRIC FOR SUPPORT.

THE STAKES AND FRAME.


NOTE: INSTALL ONE OF THE INLET PROTECTION OPTIONS SHOWN PRIOR TO CONSTRUCTION

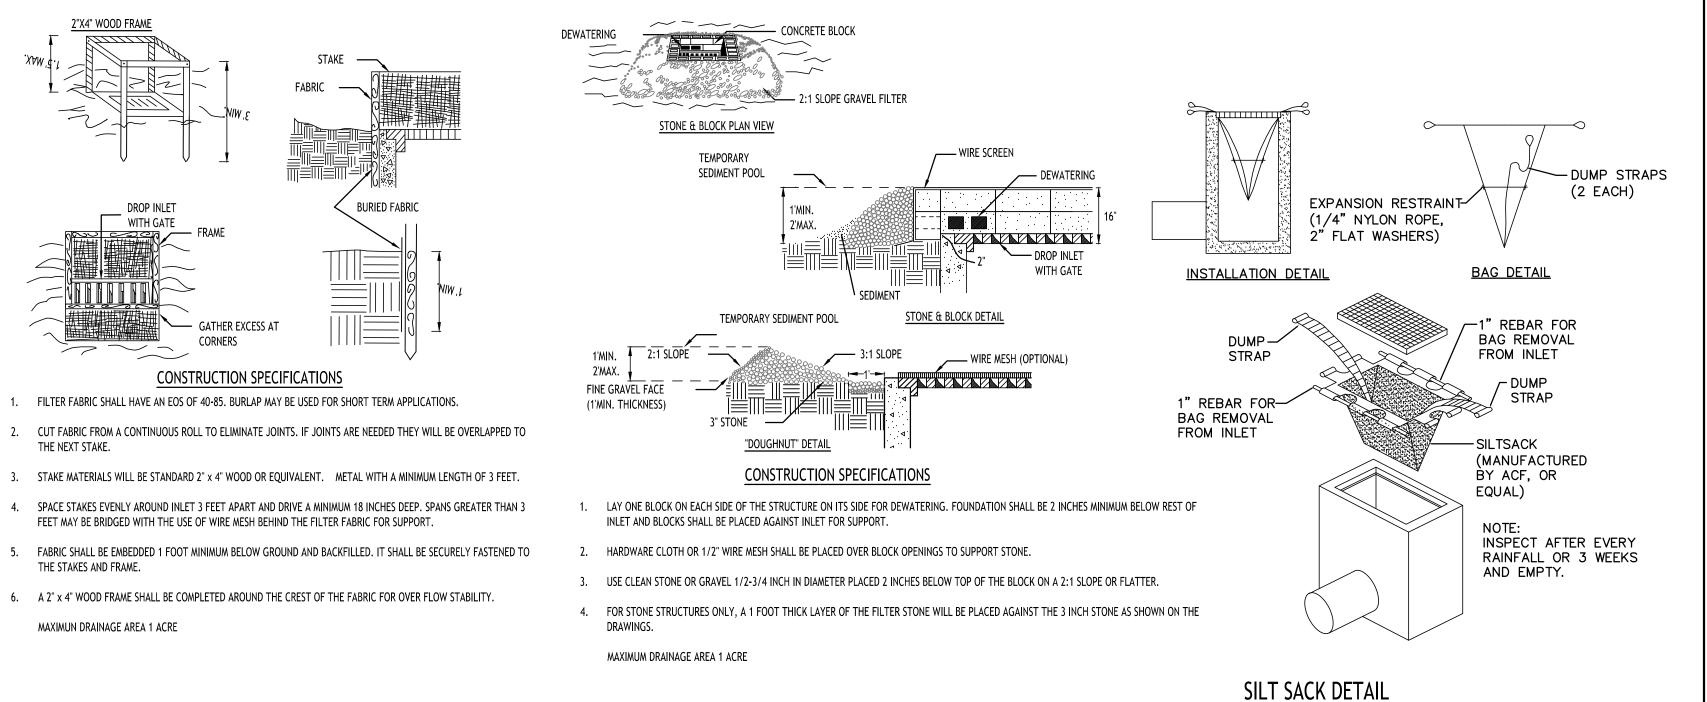

INLET PROTECTION DETAIL 3

STONE CHECK DAM DETAIL

NOT TO SCALE

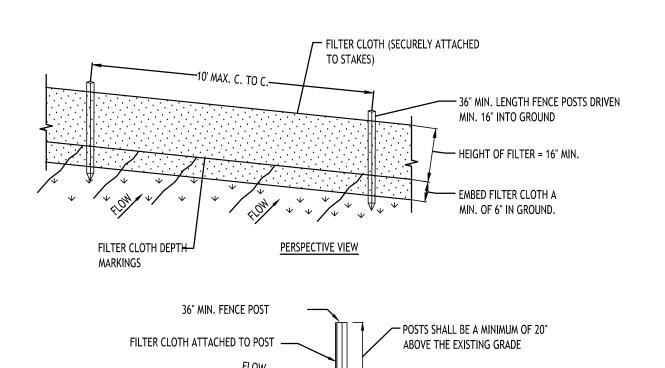

CONSTRUCTION SPECIFICATIONS


SECTION VIEW

EMBED FILTER CLOTH

A MIN. OF 6" IN GROUND

- WOVEN FENCE TO BE FASTENED SECURELY TO FENCE POSTS WITH WIRE TIES OR STAPLES. POSTS SHALL BE STEEL EITHER "T" OR "U" TYPE OR HARDWOOD.
- 2. WHEN TWO SECTIONS OF FILTER CLOTH ADJOIN EACH OTHER THEY SHALL BE OVER-LAPPED BY SIX INCHES AND FOLDED. FILTER CLOTH SHALL BE EITHER FILTER X, MIRAFI 100X, STABILINKA T140N, OR APPROVED EQUIVALENT.
- 3. MAINTENANCE SHALL BE PERFORMED AS NEEDED AND MATERIAL REMOVED WHEN "BULGES" DEVELOP IN THE SILT FENCE.


SILT FENCE DETAIL NOT TO SCALE

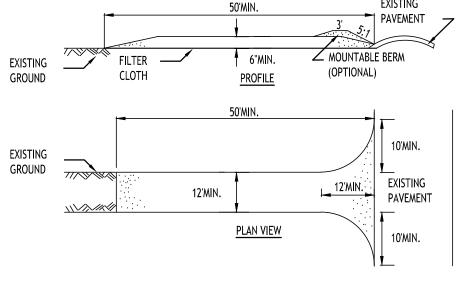


CONSTRUCTION SPECIFICATIONS

- 1. STONE SIZE USE 2" STONE, OR RECLAIMED OR RECYCLED CONCRETE EQUIVALENT.
- 2. LENGTH NOT LESS THAN 50 FEET (EXCEPT ON A SINGLE RESIDENCE LOT WHERE A 30 FOOT MINIMUM LENGTH WOULD
- 3. THICKNESS NOT LESS THAN SIX (6) INCHES.
- 4. WIDTH TWELVE (12) FOOT MINIMUM, BUT NOT LESS THAN THE FULL WIDTH AT POINTS WHERE INGRESS OR EGRESS OCCURS. TWENTY-FOUR (24) FOOT IF SINGLE ENTRANCE TO SITE.
- 5. FILTER CLOTH WILL BE PLACED OVER THE ENTIRE AREA PRIOR TO PLACING OF STONE.
- 6. SURFACE WATER ALL SURFACE WATER FLOWING OR DIVERTED TOWARD CONSTRUCTION ENTRANCES SHALL BE PIPED ACROSS THE ENTRANCE. IF PIPING IS IMPRACTICAL, A MOUNTABLE BERM WITH 5:1 SLOPES WILL BE PERMITTED.
- MAINTENANCE THE ENTRANCE SHALL BE MAINTAINED IN A CONDITION WHICH WILL PREVENT TRACKING OR FLOWING OF SEDIMENT ONTO PUBLIC RIGHTS-OF-WAY, ALL SEDIMENT SPILLED, DROPPED, WASHED OR TRACTED ONTO PUBLIC RIGHTS-OF-WAY MUST BE REMOVED IMMEDIATELY.
- 8. WHEN WASHING IS REQUIRED, IT SHALL BE DONE ON A AREA STABILIZED WITH STONE AND WHICH DRAINS INTO AN APPROVED SEDIMENT TRAPPING DEVICE.
- 9. PERIODIC INSPECTION AND NEEDED MAINTENANCE SHALL BE PROVIDED AFTER EACH RAIN.

STABILIZED CONSTRUCTION ENTRANCE DETAIL NOT TO SCALE

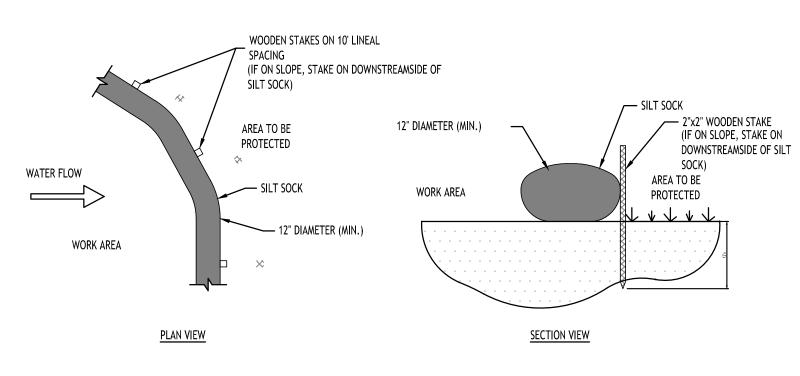

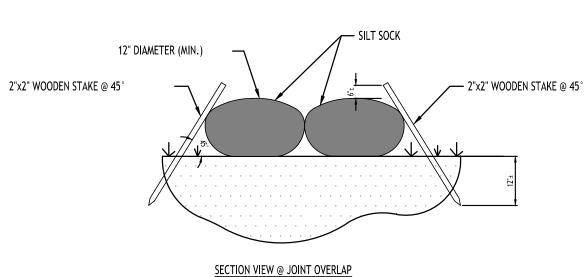


NOTES:

CONTRACTOR SHALL INSPECT AND MAINTAIN SILT SOCK AS NEEDED DURING THE DURATION OF CONSTRUCTION PROJECT.

CONTRACTOR SHALL REMOVE SEDIMENT COLLECTED AT THE BASE OF THE SILT SOCK WHEN IT HAS REACHED ¹/₂ OF THE EXPOSED HEIGHT OF THE SILT SOCK. ALTERNATIVELY, RATHER THAN CREATE A SOIL DISTURBING ACTIVITY, THE ENGINEER MAY CALL FOR ADDITIONAL SILT SOCK TO BE ADDED AT AREAS OF HIGH SEDIMENTATION, PLACED IMMEDIATELY ON TOP OF THE EXISTING SEDIMENT LADEN SILT SOCK.


SILT SOCK SHALL BE OVERLAPPED 12" AT JOINTS AND STAKED ON EACH SIDE OF THE SOCK AT A 45° ANGLE

> SILT SOCK DETAIL NOT TO SCALE

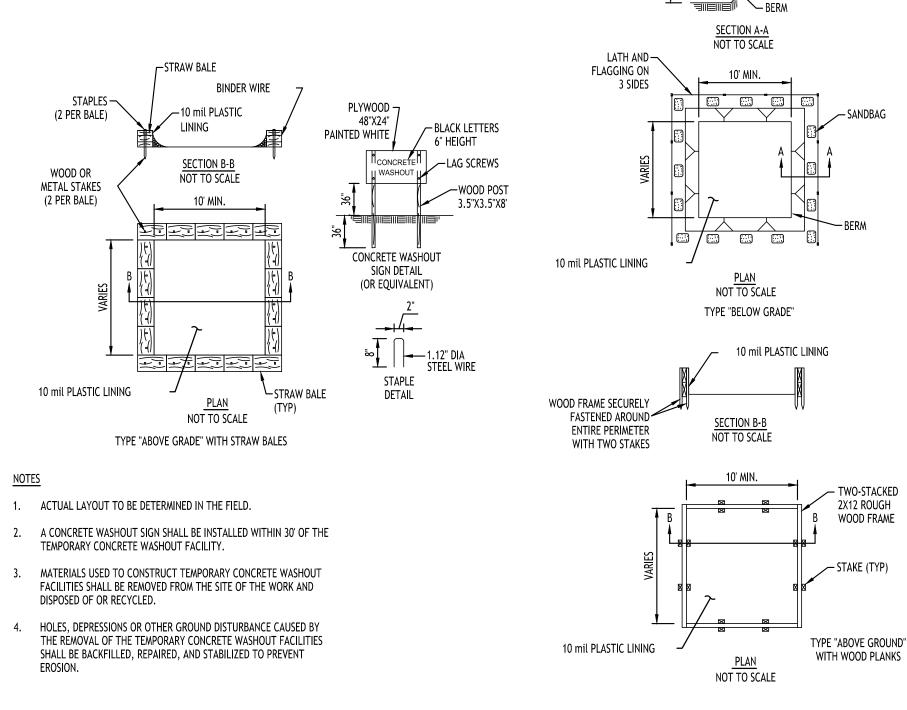

NOT TO SCALE



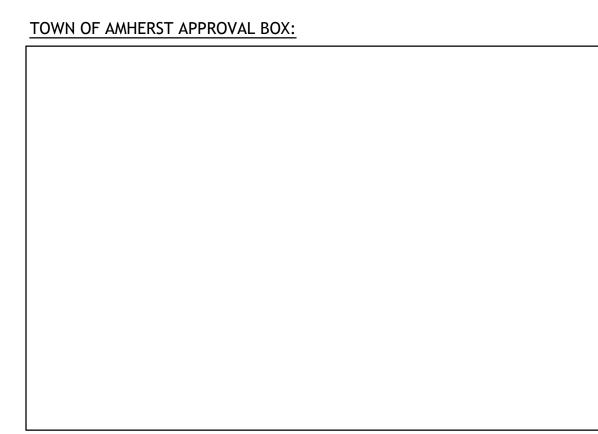

DRAWING NAME: Demolition & **Erosion Control** Details

D

•—


 $\mathbf{\Omega}$

Date: Drawn By: Scale: DRAWING NO.


11/19/24


C. Wood

As Noted

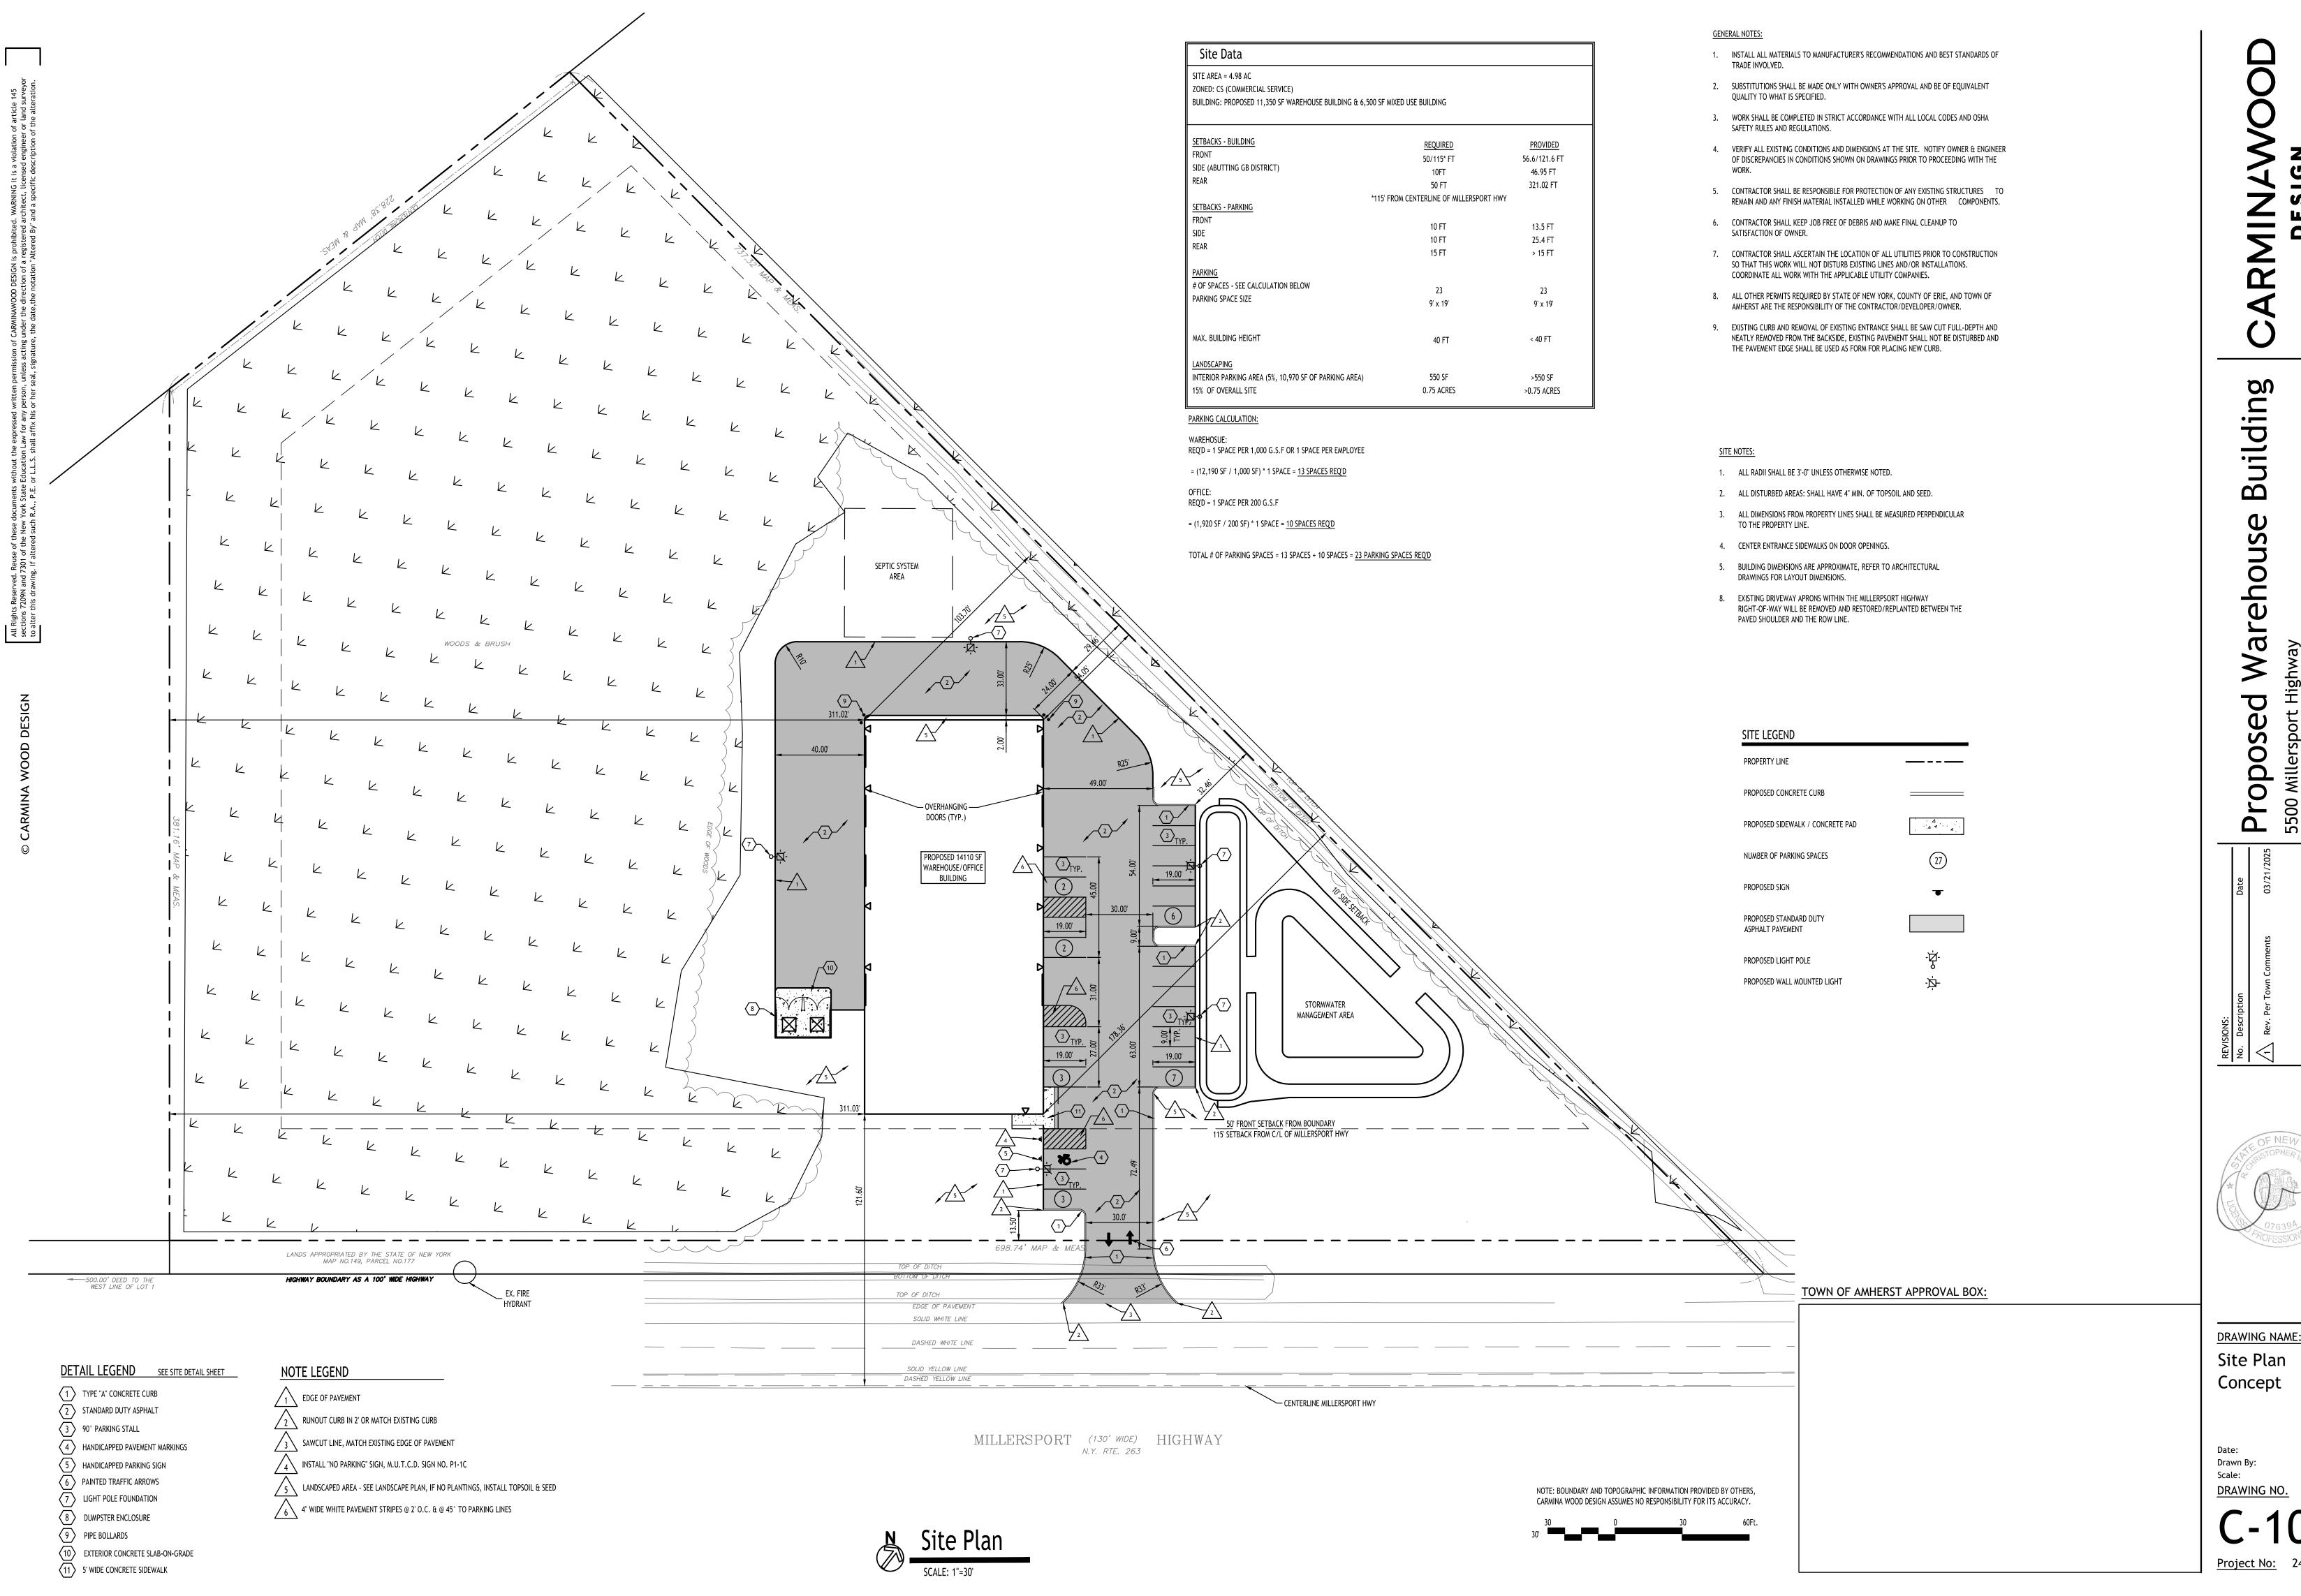

11/19/24 C. Wood

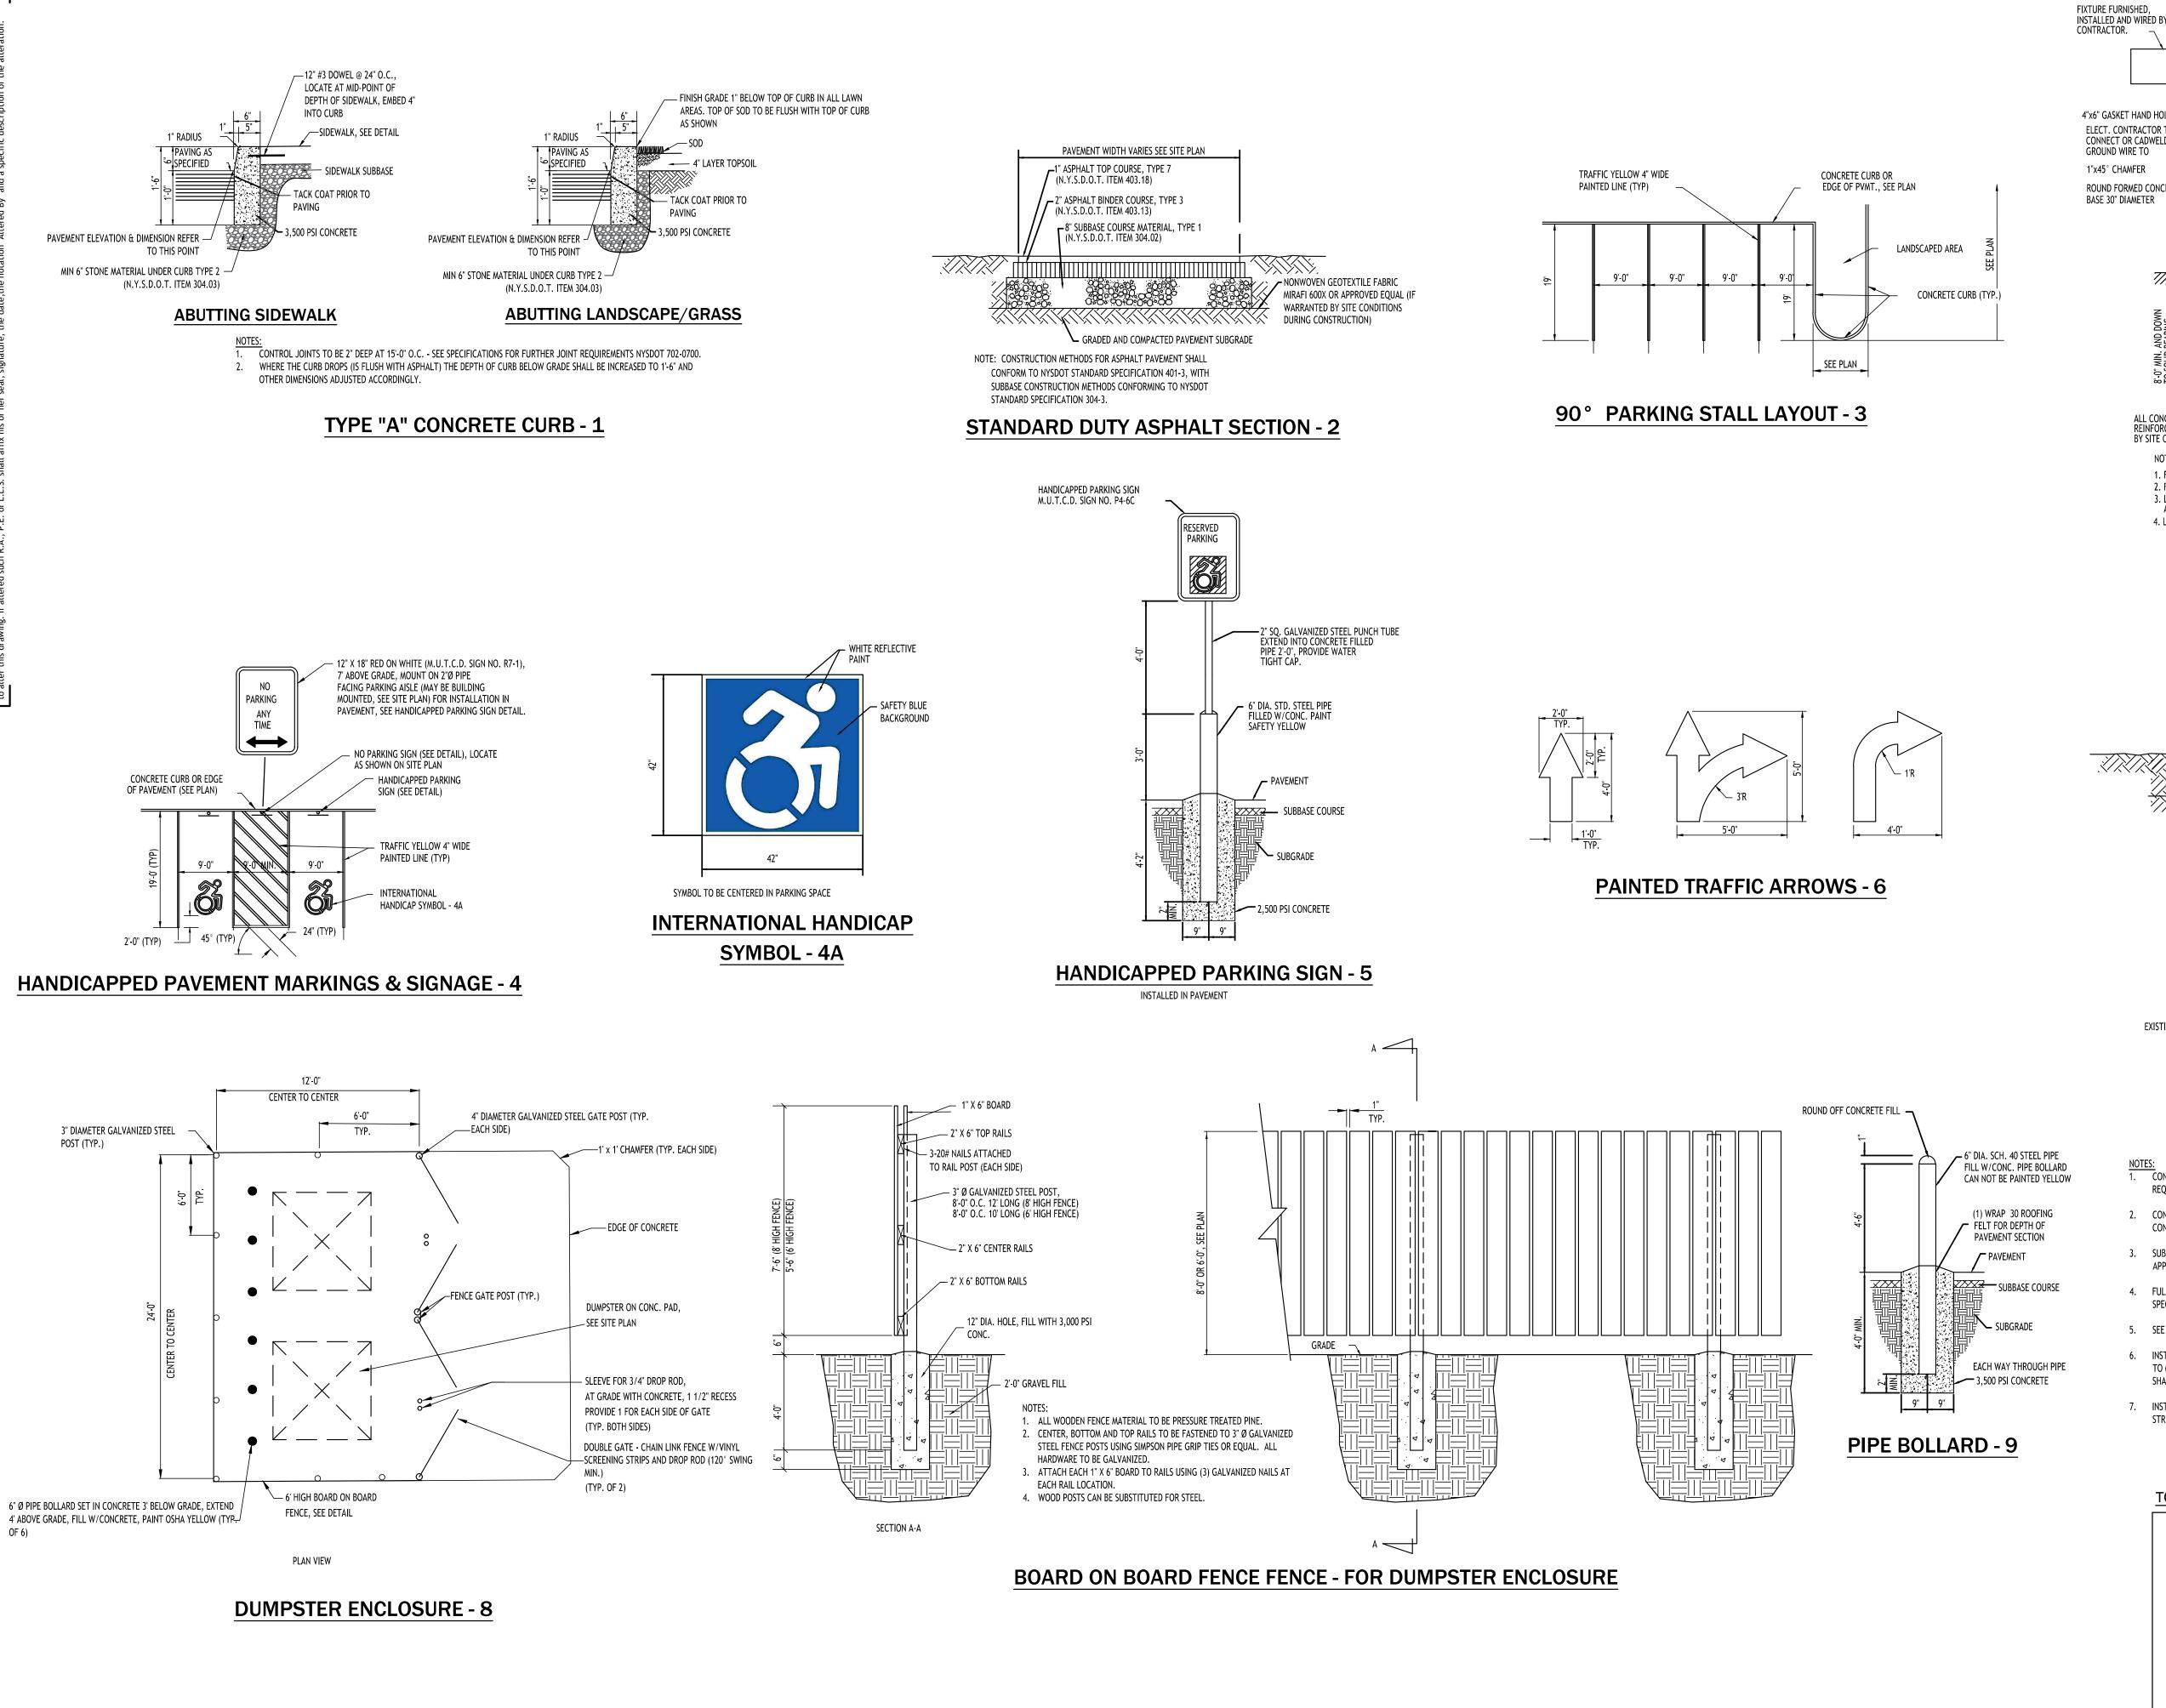


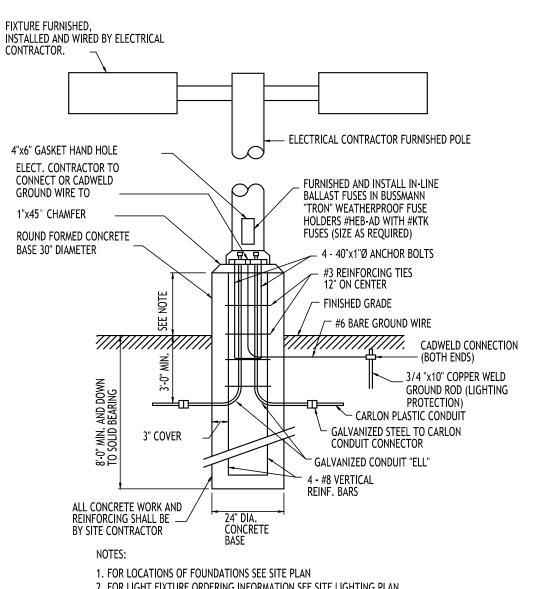

2. FOR LIGHT FIXTURE ORDERING INFORMATION SEE SITE LIGHTING PLAN 3. LIGHTING FIXTURES SHALL BE A MAXIMUM OF 25 FEET IN HEIGHT WITHIN PARKING AND SHALL BE A MAXIMUM OF 15 FEET WITHIN NON-VECHICULAR PEDESTRIAN AREAS 4. LIGHT POLE BASE EXPOSURE ABOVE GRADE SHALL BE: IN CURBED ISLANDS: 6" ABOVE TOP OF CURB ELEVATION IN PAVEMENT: 30" ABOVE GRADE


LIGHT POLE FOUNDATION - 7

IN NON-CURBED GRASS AREAS: 6" ABOVE GRADE

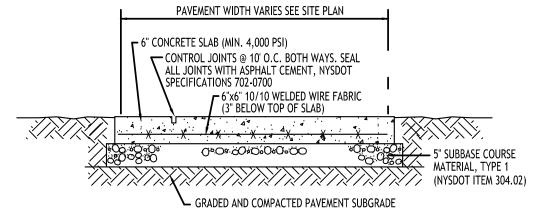

NOTE: CONCRETE PAVEMENT MATERIAL SHALL CONFORM TO NYSDOT STANDARD SPECIFICATION 501 AND CONSTRUCTION METHODS SHALL CONFORM TO NYSDOT STANDARD SPECIFICATION 502-3.

EXTERIOR CONCRETE SLAB-ON-GRADE SECTION - 10

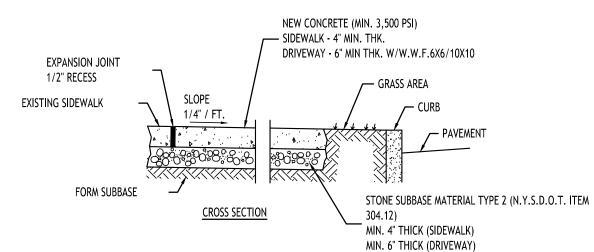

NOTES:

CONTROL JOINTS TO BE AT 5'-0" O.C., BOTH WAYS WHERE APPLICABLE. SEE SPECIFICATIONS FOR FURTHER JOINT REQUIREMENTS NYSDOT 702-0700.

2. CONCRETE SIDEWALK AND DRIVEWAY MATERIAL SHALL CONFORM TO NYSDOT STANDARD SPECIFICATION 501 AND CONSTRUCTION METHODS SHALL CONFORM TO NYSDOT STANDARD SPECIFICATION 608-3.

SUBBASE GRADE SHALL FOLLOW THE PROPOSED GRADE OF THE SIDEWALK AND SLOPE AWAY FROM BUILDING WHERE APPLICABLE, PROVIDE CONTINUOUS STONE PATH TO CURB UNDERDRAIN WHERE PROVIDED.

4. FULL DEPTH EXPANSION JOINTS SHALL BE INSTALLED EVERY 20' O.C., BOTHWAYS WHERE APPLICABLE. SEE SPECIFICATIONS FOR FURTHER JOINT REQUIREMENTS NYSDOT 702-0700.


5. SEE CURB DETAIL FOR DOWLING REQUIREMENTS WHERE ABUTTING CURB.

6. INSTALL 6" LONG #3 DOWELS @ 12" O.C. WHERE SIDEWALK ABUTS A BUILDING WALL AT AN ENTRANCE, THICKEN SIDEWALK TO 6" AT BUILDING WALL AND INSTALL DOWEL CENTERED IN THE 6" DEPTH. DOWELS AND THICKENING OF SIDEWALK SHALL EXTEND 18" EITHER SIDE OF ENTRANCE.

7. INSTALL 1/2" PREMOLDED EXPANSION JOINT WITH BACKER ROD & SEALANT WHERE SIDEWALK ABUTS BUILDING OR OTHER STRUCTURE.

CONCRETE SIDEWALK - 11

TOWN OF AMHERST APPROVAL BOX:

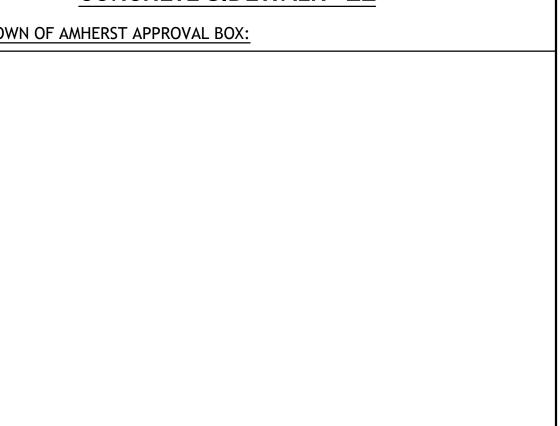

Ë $\mathbf{\Omega}$



DRAWING NAME: Site Details

Drawn By: DRAWING NO.


Date:


Scale:

11/19/24

C. Wood

As Noted

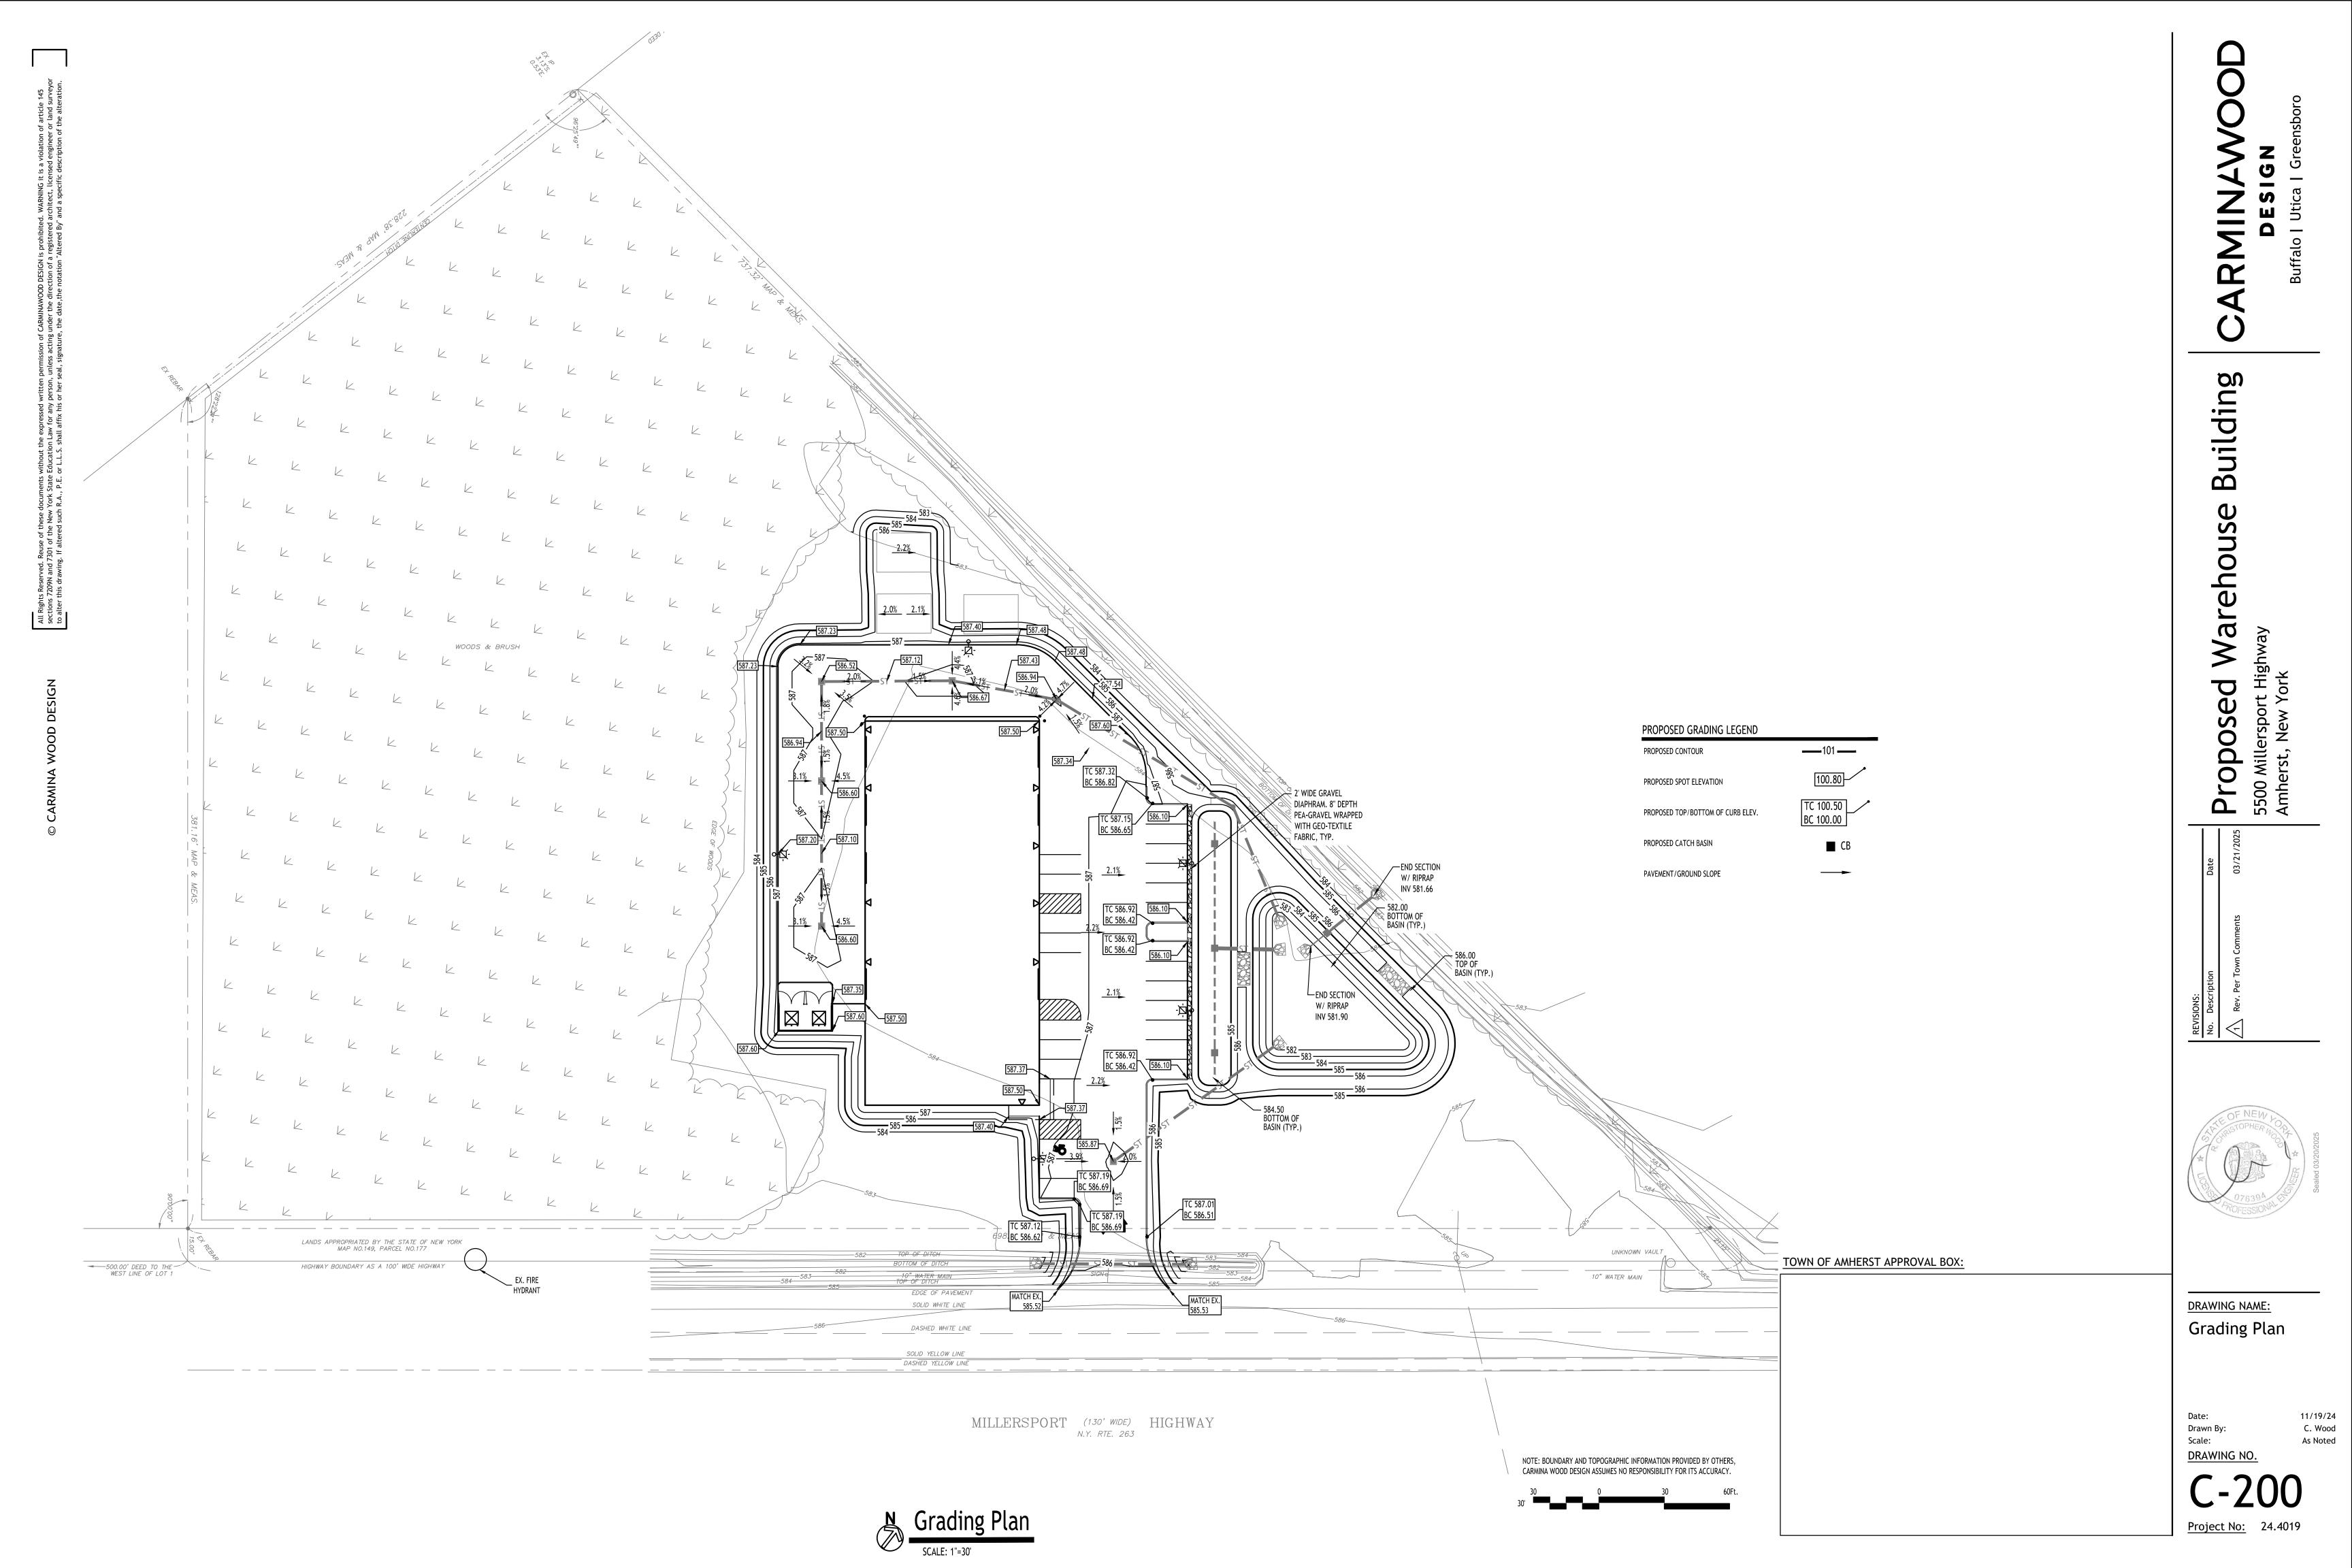

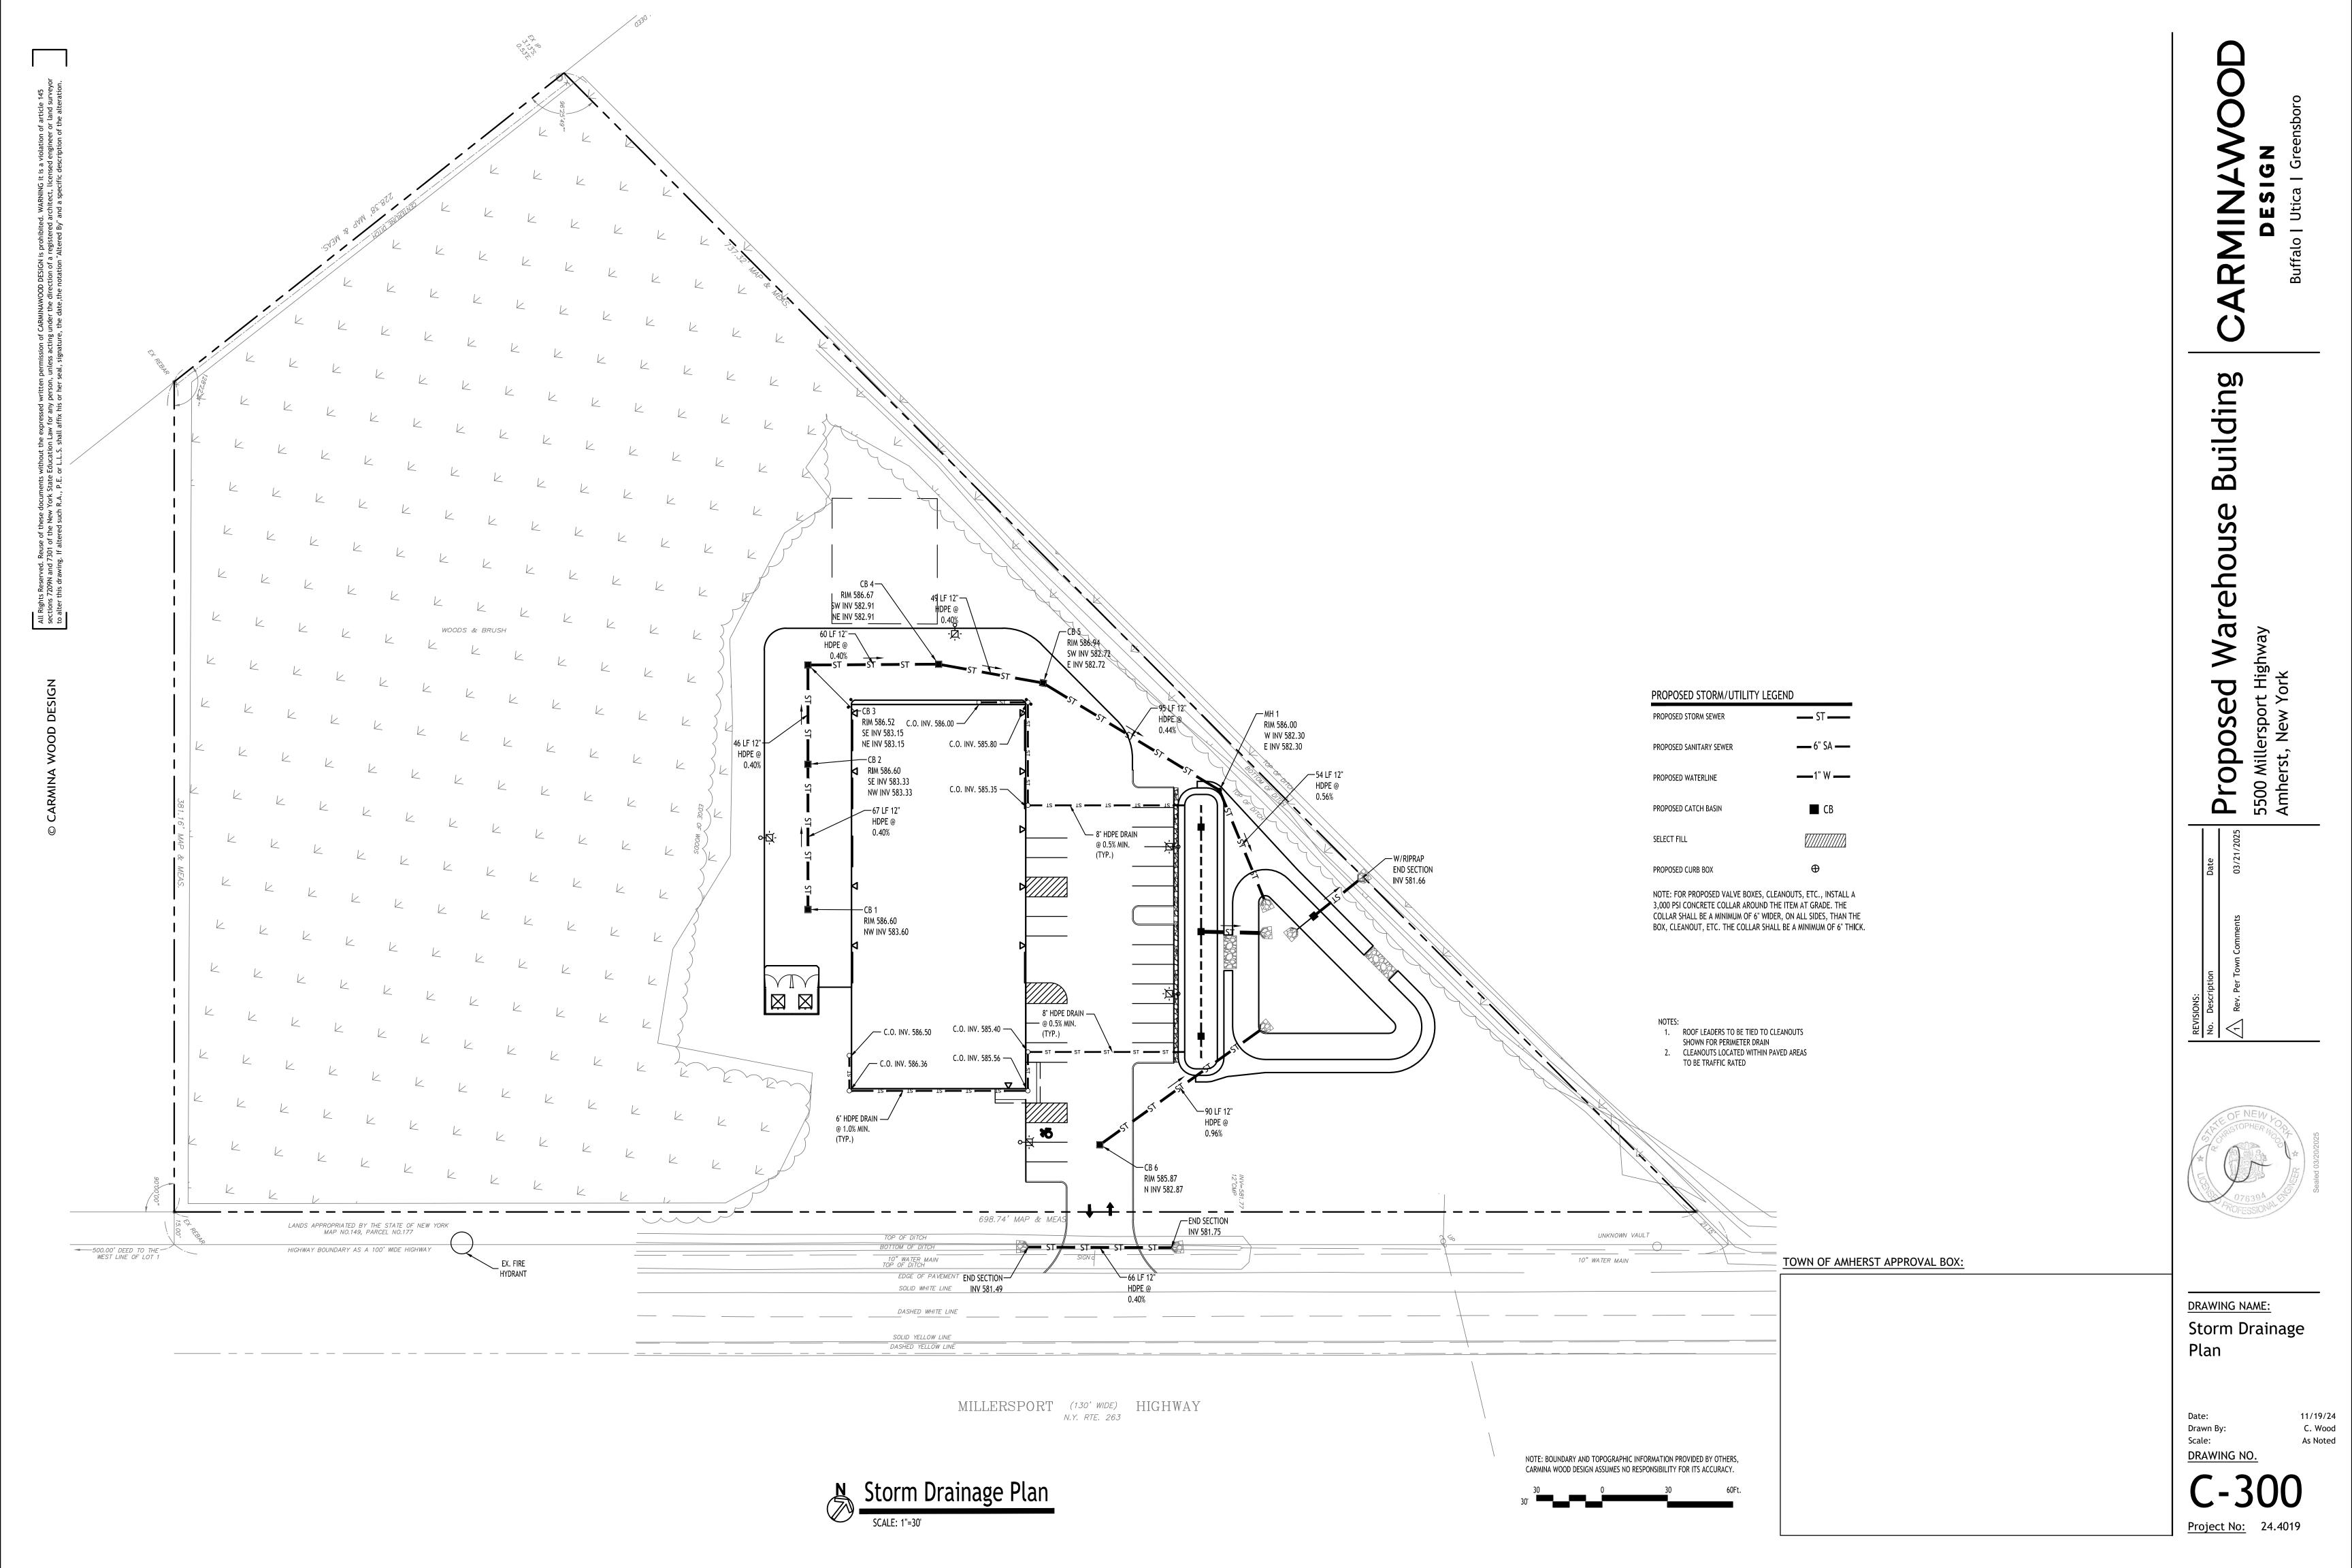



 $\mathbf{\Omega}$


DRAWING NAME: Basin **Details**


Date: Drawn By: Scale:


11/19/24

C. Wood

DRAWING NO. <u>Project No:</u> 24.4019

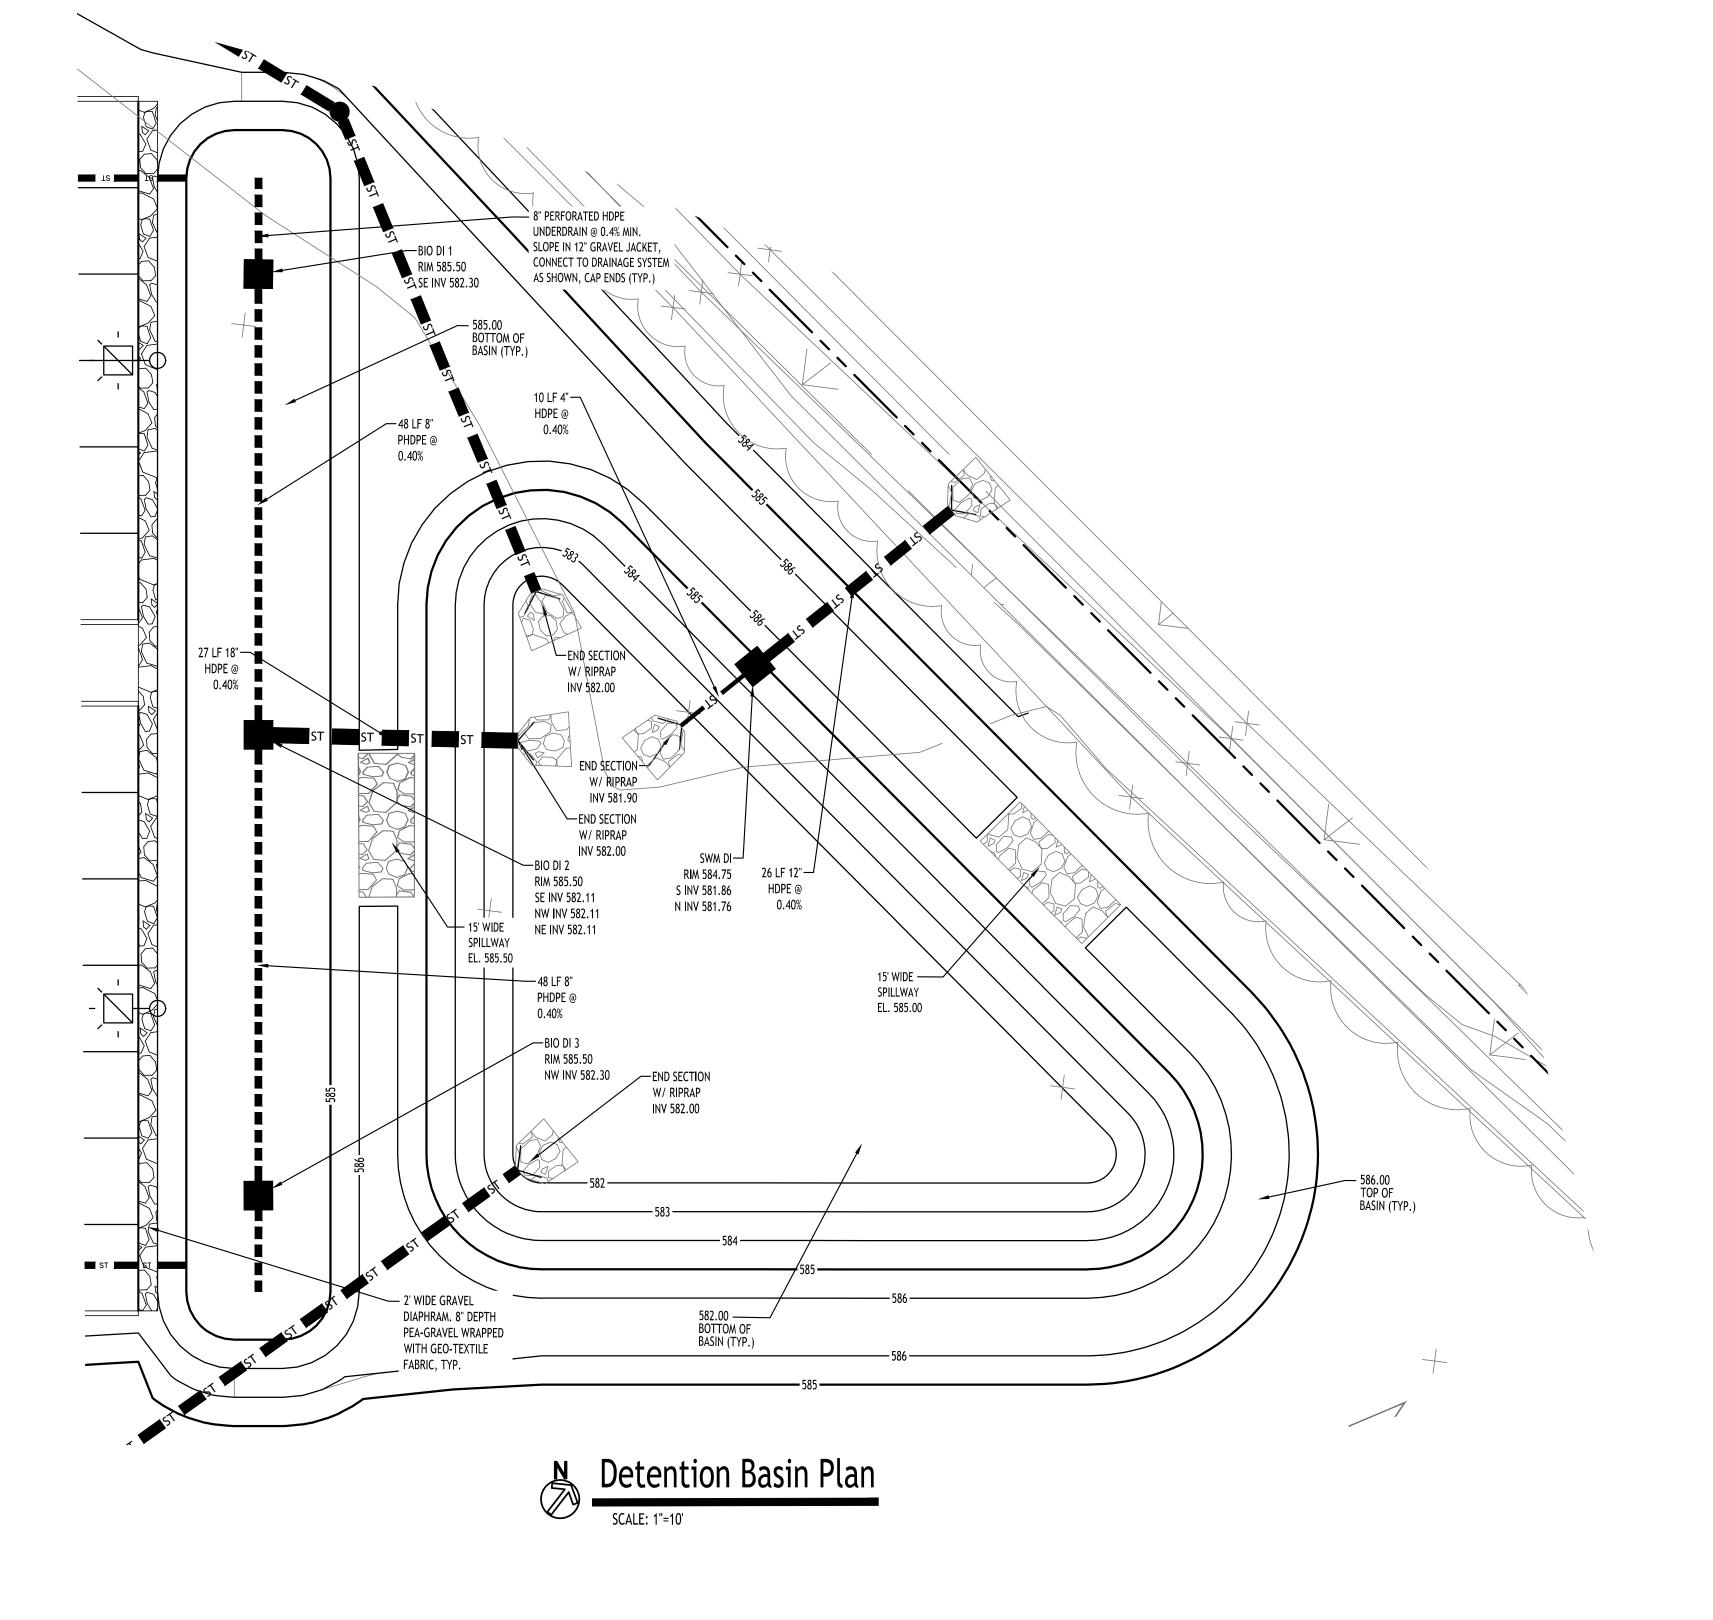


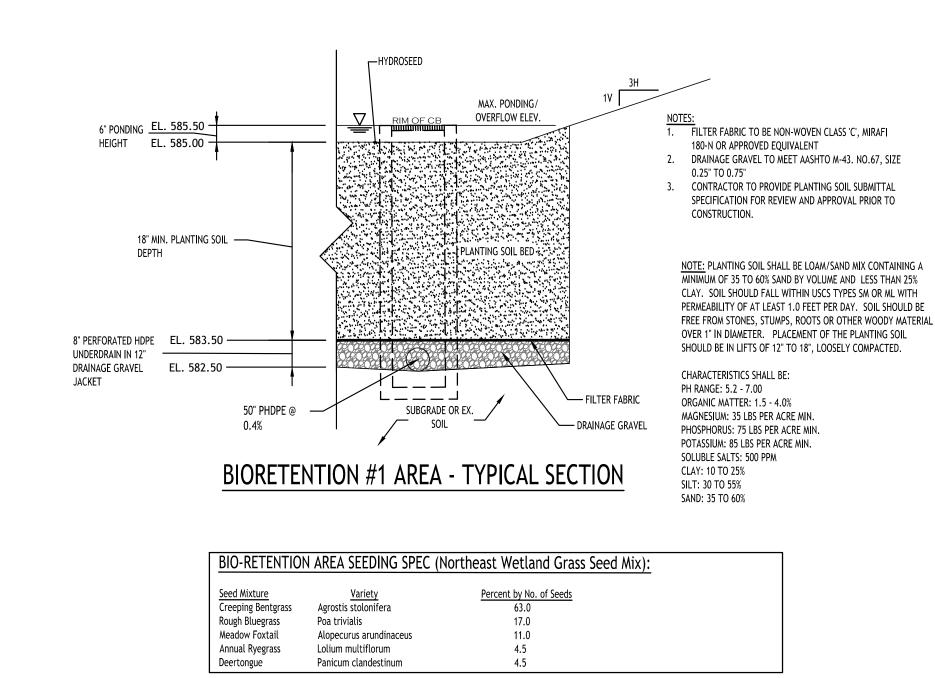

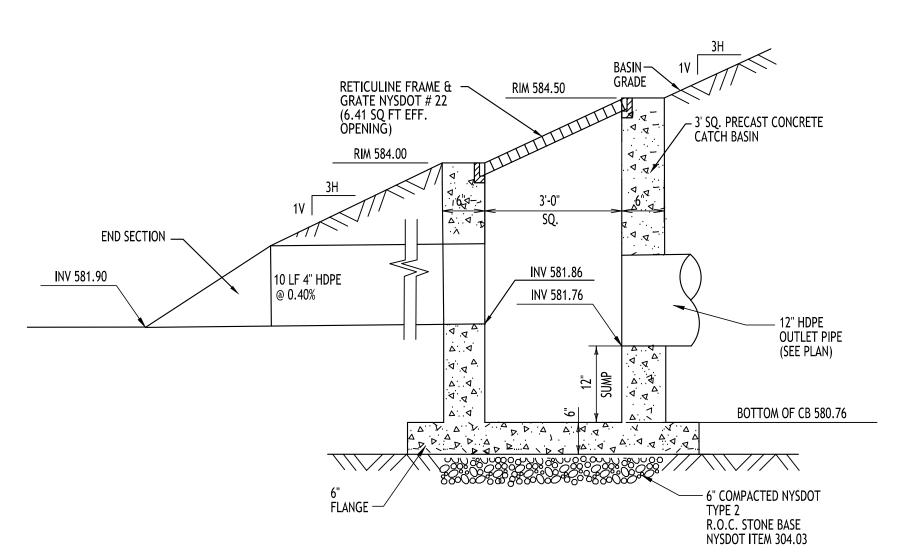


RETENTION BASIN OUTLET STRUCTURE - SWM 1 DI

TOWN OF AMHERST APPROVAL BOX:

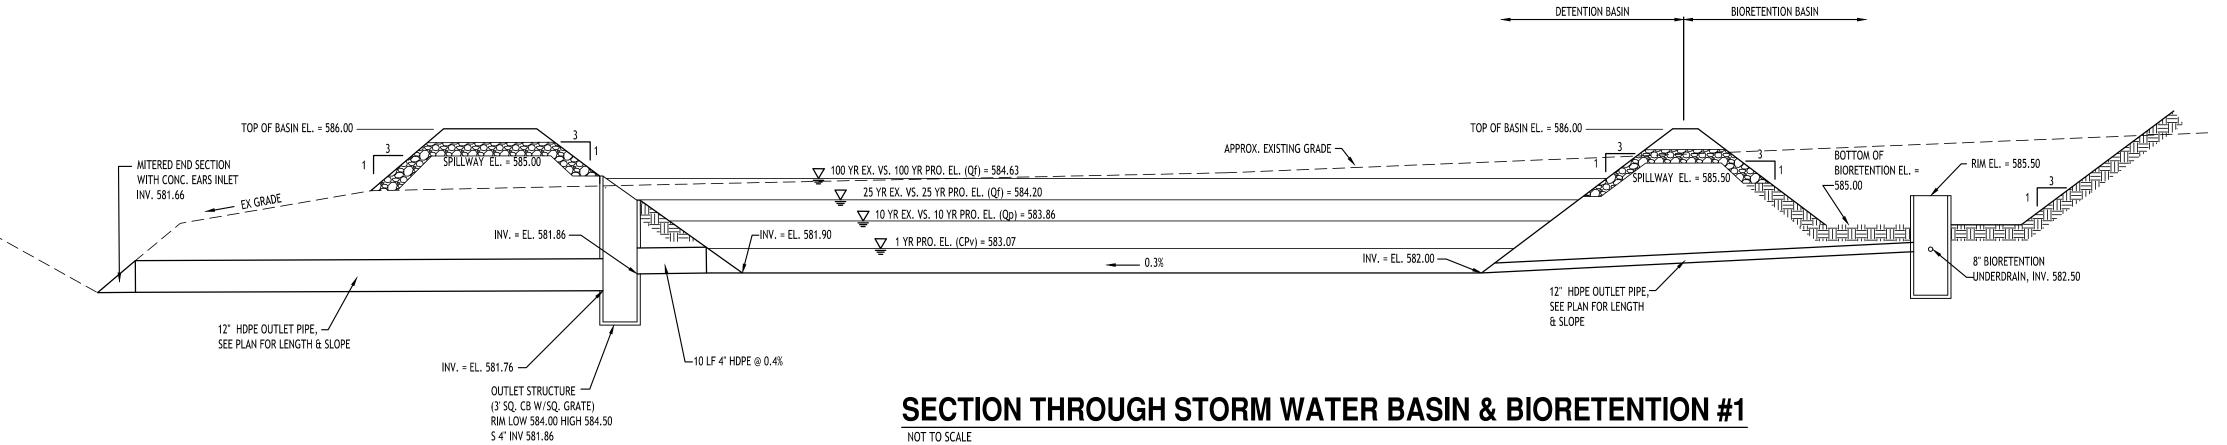

N 12" INV 581.76

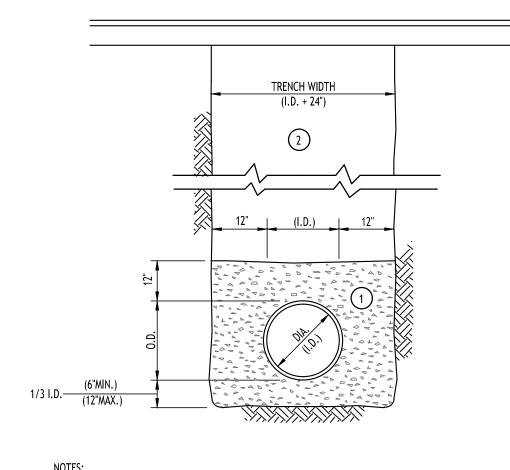

- A. PIPE INSTALLATION SHALL BE IN ACCORDANCE WITH MANUFACTURERS RECOMMENDATIONS.
- B. TRENCHING OPERATIONS SHALL INCLUDE ALL NECESSARY DEWATERING.
- C. TRENCH DETAILS ARE ONLY SHOWN FOR PURPOSES OF MATERIAL PLACEMENT AND MAXIMUM PAY LIMITS.
- D. AN OSHA APPROVED MOVABLE PROTECTIVE TRENCH SHIELD SHALL BE USED IN ALL UNSHEETED TRENCH AREAS.

PIPE BEDDING MATERIAL (NYSDOT 1985 EDITION)

NO. 1 CRUSHED STONE OR CRUSHED GRAVEL WITH A GRADATION CONFORMING WITH NYSDOT SECTION 703-02. THE MATERIAL SHALL BE WELL GRADED WITH NO PARTICLES LARGER THAN ONE INCH AND HAVING A MAXIMUM GRADATION MEETING THE LIMITS DESCRIBED IN THE SPECIFICATIONS. THE BEDDING SHALL BE COMPACTED IN 6" LIFTS WITH EQUIPMENT ACCEPTABLE TO THE PIPE MANUFACTURER.

NO SLAG SHALL BE ALLOWED FOR MATERIAL

TYPE 2 CRUSHED STONE OR CRUSHED GRAVEL WITH A GRADATION CONFORMING WITH NYSDOT SECTION 304-2.02 TYPE 2. THE MATERIAL SHALL BE WELL GRADED WITH NO PARTICLES LARGER THAN TWO INCHES AND HAVING A MAXIMUM GRADATION MEETING THE LIMITS DESCRIBED IN THE SPECIFICATIONS. THE BEDDING SHALL BE COMPACTED IN 6" LIFTS WITH EQUIPMENT ACCEPTABLE TO THE PIPE

STORM SEWER TRENCH SECTION

IN PAVED AREAS

NO SLAG SHALL BE ALLOWED FOR MATERIAL

BACKFILL MATERIAL SHALL BE NATIVE SOIL CONTAINING NO UNSUITABLE MATERIAL COMPACTED IN 6" LIFTS.

PIPE BEDDING MATERIAL (NYSDOT 1985 EDITION)

NO. 1 CRUSHED STONE OR CRUSHED GRAVEL WITH A GRADATION CONFORMING WITH NYSDOT SECTION 703-02. THE MATERIAL

NO SLAG SHALL BE ALLOWED FOR MATERIAL

SHALL BE WELL GRADED WITH NO PARTICLES LARGER THAN ONE INCH AND HAVING A MAXIMUM GRADATION MEETING THE LIMITS DESCRIBED IN THE SPECIFICATIONS. THE BEDDING SHALL BE COMPACTED IN 6" LIFTS WITH EQUIPMENT ACCEPTABLE TO THE PIPE

A. PIPE INSTALLATION SHALL BE IN ACCORDANCE WITH MANUFACTURERS RECOMMENDATIONS.

B. TRENCHING OPERATIONS SHALL INCLUDE ALL NECESSARY DEWATERING.

C. TRENCH DETAILS ARE ONLY SHOWN FOR PURPOSES OF MATERIAL PLACEMENT AND MAXIMUM PAY LIMITS.

D. AN OSHA APPROVED MOVABLE PROTECTIVE TRENCH SHIELD SHALL


BE USED IN ALL UNSHEETED TRENCH AREAS.

__6" TOPSOIL (MIN.)


TOP OF PIPE ZONE

MANUFACTURER.

STORM SEWER TRENCH SECTION IN UNPAVED AREAS NOT TO SCALE

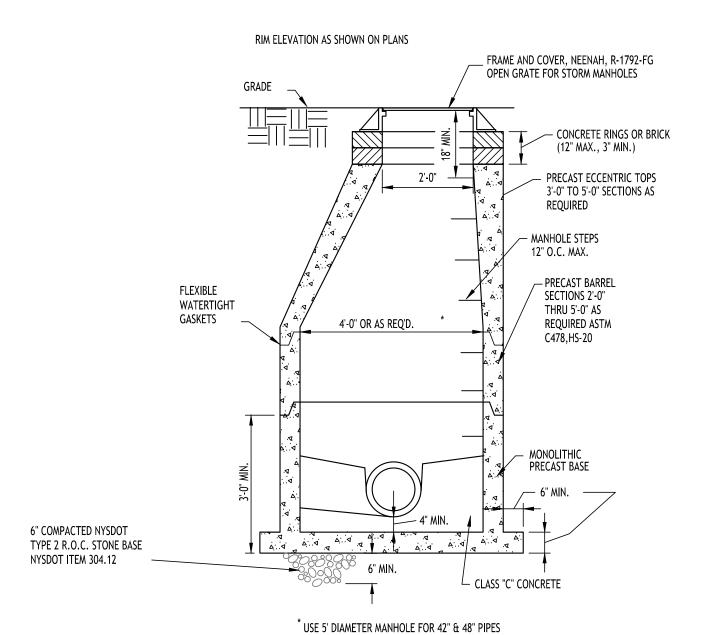


TYPICAL STORM MANHOLE DETAIL

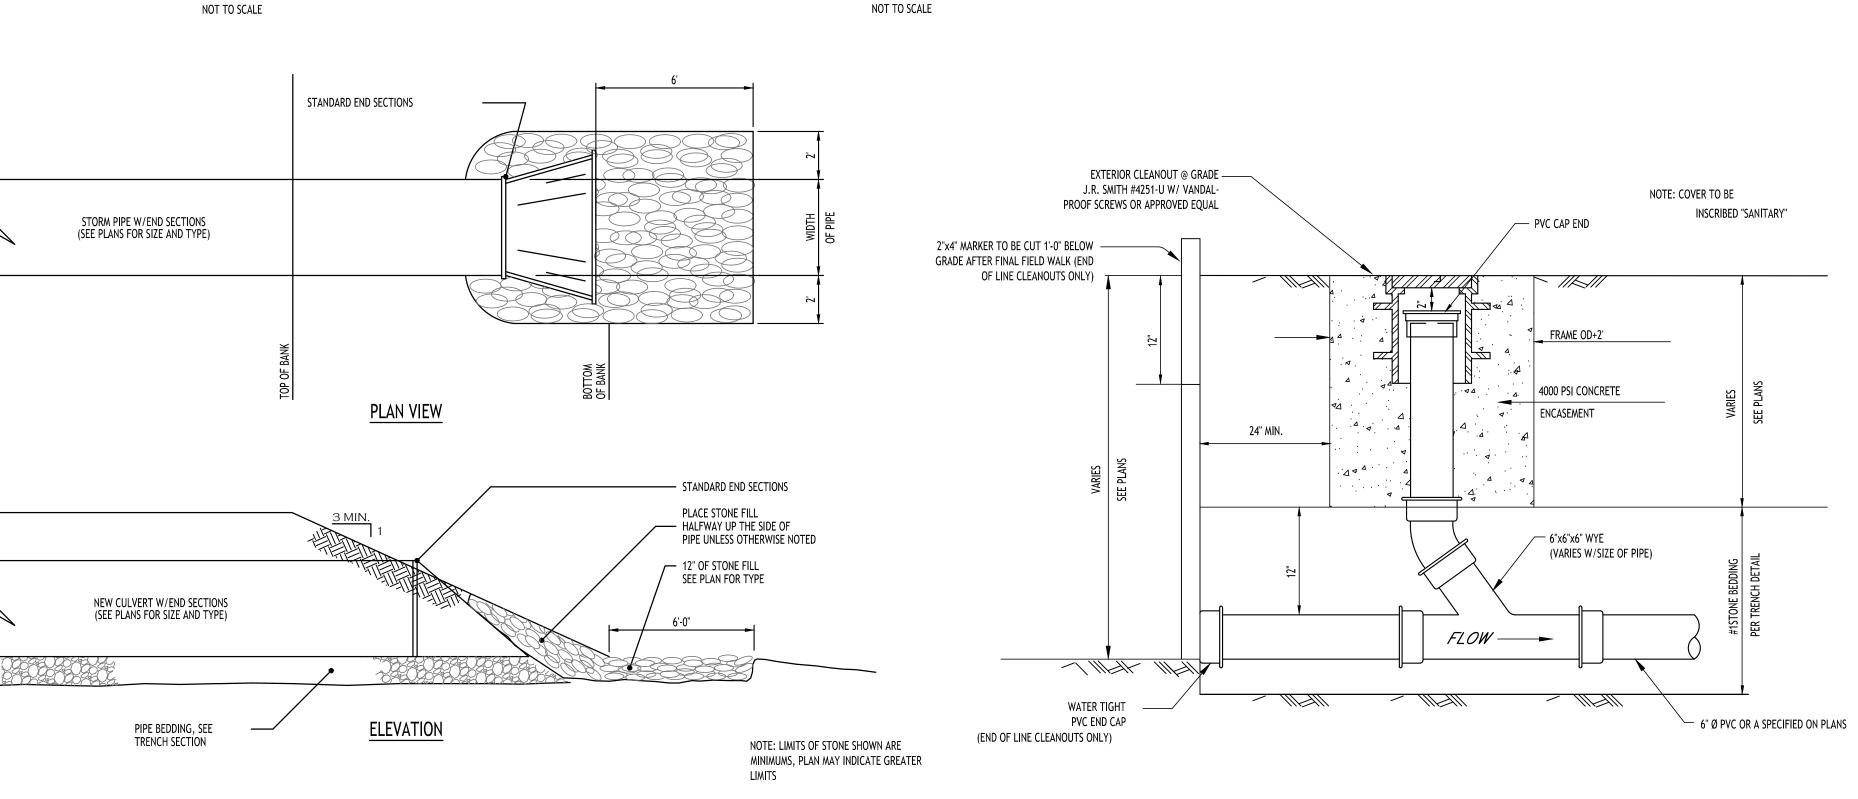


LAMPHOLE/CLEANOUT IN LAWN/FIELD AREAS NOT TO SCALE

TYPICAL PIPE OUTLET W/ END SECTION & RIP RAP NOT TO SCALE

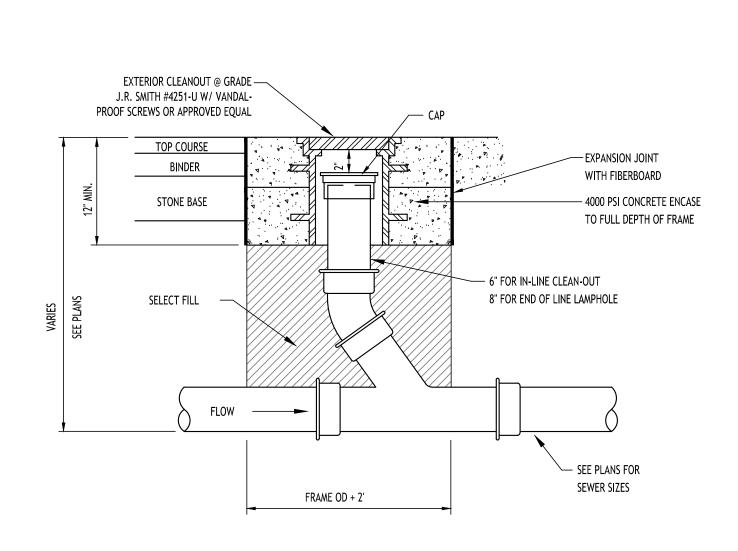


LAMPHOLE/CLEANOUT IN PAVEMENT/SIDEWALK

NOT TO SCALE

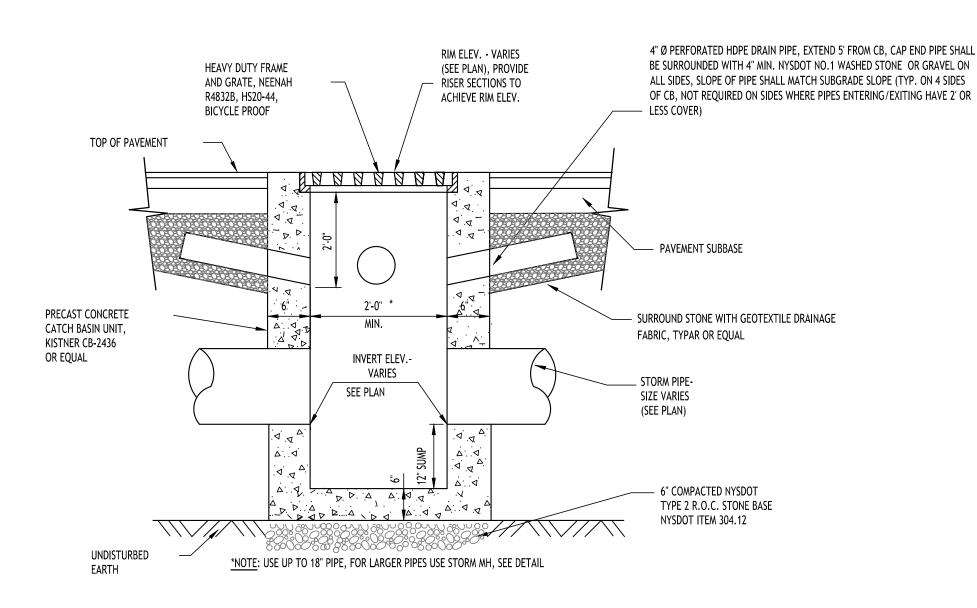

TYPICAL PRECAST CATCH BASIN NOT TO SCALE

TOWN OF AMHERST APPROVAL BOX:

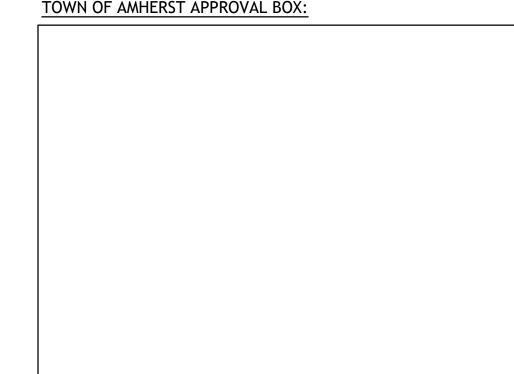

DRAWING NAME: Storm Drainage **Details**

Date: Drawn By: Scale: DRAWING NO.


11/19/24

C. Wood

As Noted

Uil

 $\mathbf{\Omega}$

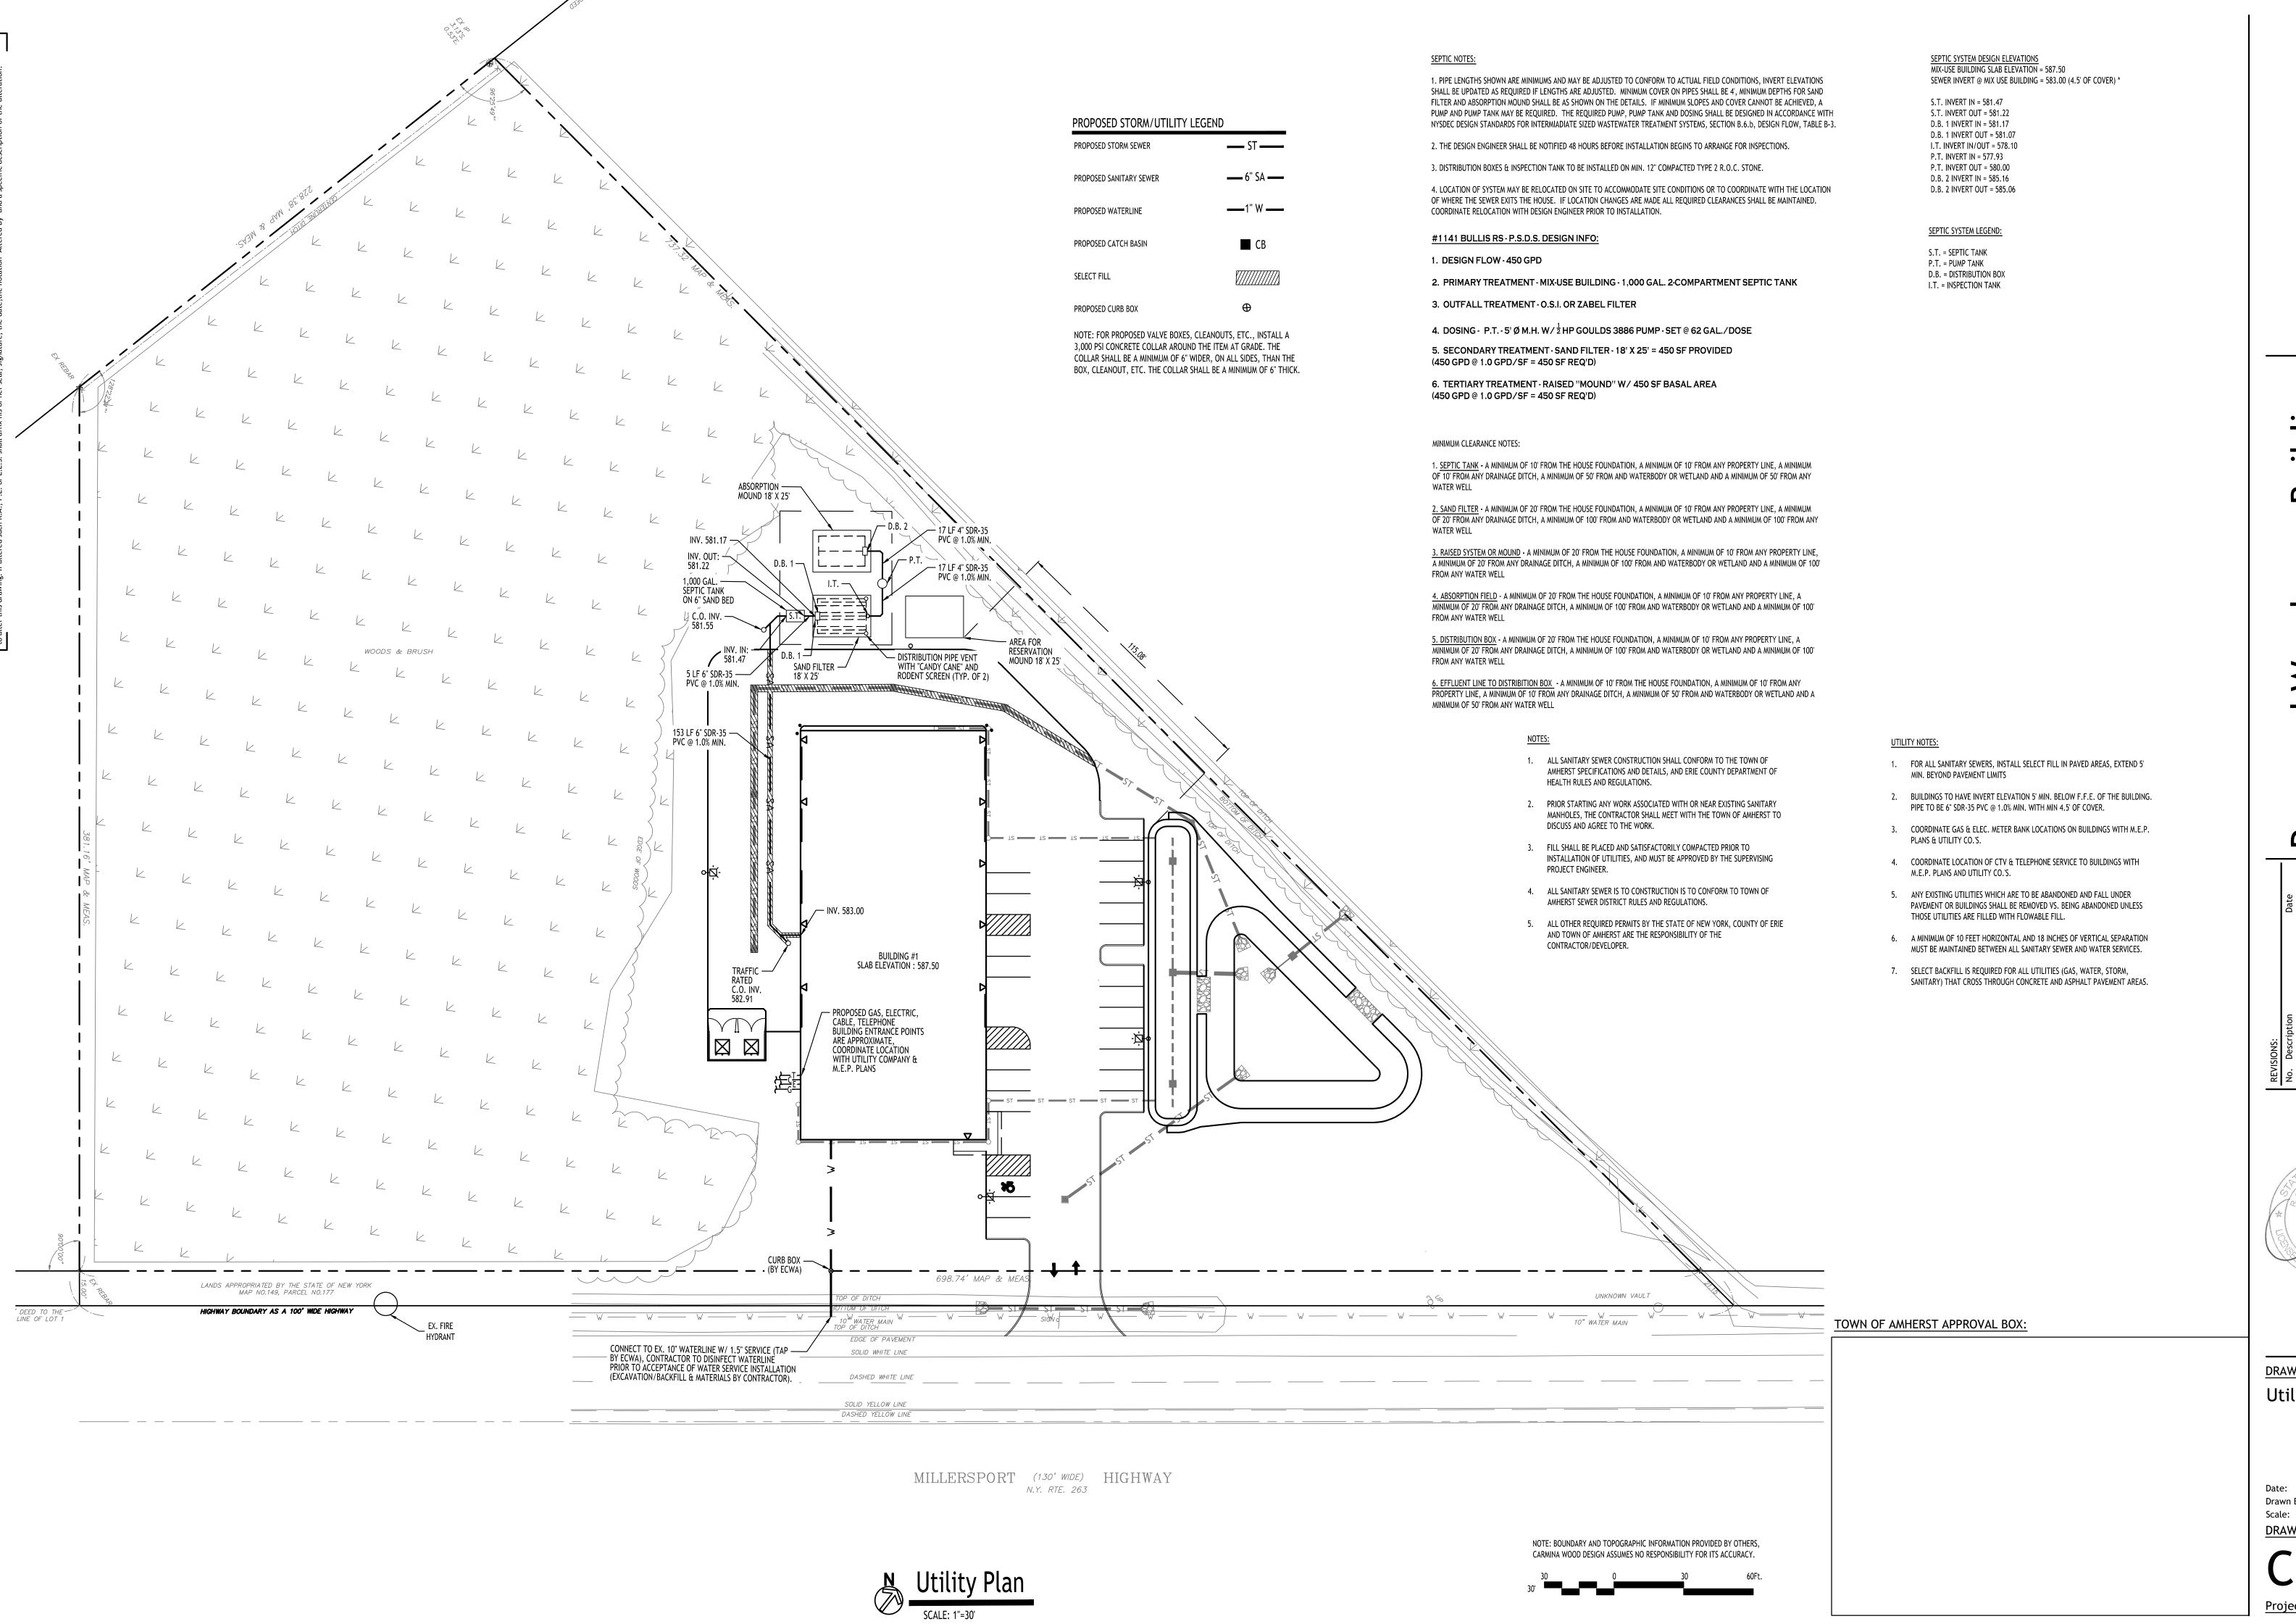

 $\mathbf{\Omega}$

DRAWING NAME: **Utility Plan**

Drawn By:


11/19/24

C. Wood

As Noted

DRAWING NO.

PUMP TANK

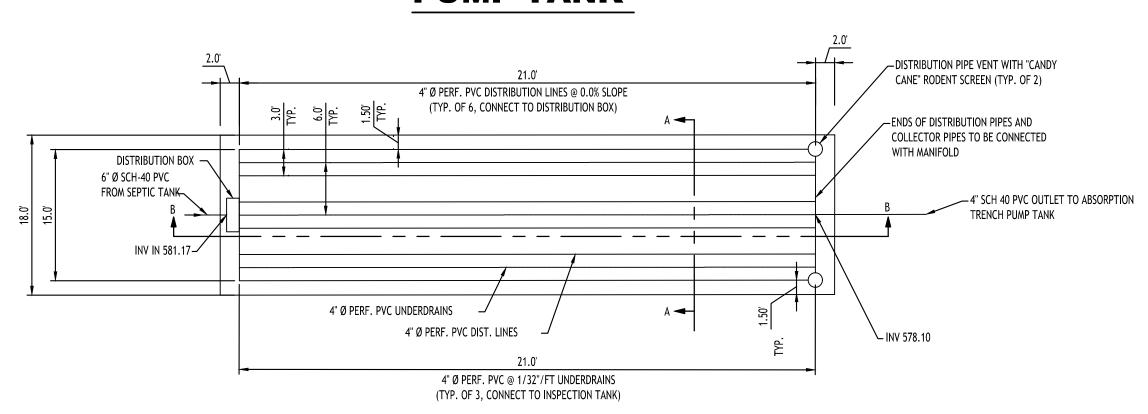

SAND FILTER PLAN

1. ALL SAND SHALL BE UNIFORM COARSE TO MEDIUM SAND (< 4% PASSINF #200 SIEVE), ALL PASSING 1/4 INCH SIEVE, HAVE A EFFECTIVE GRAIN SIZE (EGS) BETWEEN 0.25 - 1.00 mm, AN UNIFORMITY COEFFICIENT (UC) <= 4

2. IF A HDPE LINER IS USED, SEAL PENETRATIONS AND SEAMS WATER TIGHT

3. TOP OF SAND FILTER SHALL BE SLOPED TO DRAIN, AREAS AROUND THE FILTER SHALL BE GRADED TO DIVERT WATER AWAY

4. ALL HEAVY EQUIPMENT SHALL BE KEPT OFF THE SAND FILTER AREA FOLLOWING CONSTRUCTION.

5. depending on depth of high water mark or bedrock or the existing topography, the entire filter may be adjusted up or down. all required clearances and minimum slopes must be maintained. if adjustments are made to the filter, the engineer shall be notified prior to start of installation.

> 21 LF 4" Ø PERF. PVC @ 0.0% SLOPE (TYP. OF 6, CONNECT TO DISTRIBUTION BOX) EL. 586.50 FILTER CLOTH 6" MIN.TOPSOIL COVER EL. 586.25 — SEED TO LAWN #2 GRAVEL 0.5-1.0 mm 6 MIL. HDPE LINER 1/4"- 8" PEA GRAVEL -21 LF 4" Ø PERF. PVC @ 1/32"/FT -

MOUND NOTES:

(SHOWN AS SIDE TO SIDE FOR ILLUSTRATION PURPOSES).

ABOVE THE HIGH GROUND WATER ELEVATION.

A. < 10% PASSING #200 SIEVE

C. < 15% PASSING 1/2 SIEVE

NOTIFIED PRIOR TO START OF INSTALLATION.

F. U.C. BETWEEN 4 - 6

AT THE GROUND SURFACE.

FOLLOWING PLOWING.

E. E.G.S. BETWEEN 0.15 - 0.30 MM

ALLOWED IN THE MOUND AREA FOLLOWING PLOWING OF THE EXISTING SOIL.

ORIENTED TO RUN PARALLEL WITH THE NATURAL SITE CONTOURS.

6. THE ABSORPTION BED SAND SHALL MEET THE FOLLOWING CRITERIA:

D. PERCOLATION RATE OF BETWEEN 5 - 30 MIN/INCH

G. TEST RESULTS TO BE SUBMITTED TO ENGINEER FOR APPROVAL

B. => 25% PASSING #35 SIEVE TO #10 SIEVE

1. TOP OF MOUND SHALL BE SLOPED TO DRAIN, AREAS AROUND THE BASE OF THE MOUND SHALL BE GRADED TO DIVERT WATER AWAY

2. SLOPE UNDER MOUND SHALL FOLLOW SLOPE OF EXISTING GRADE, EITHER SIDE TO SIDE OR LONGITUDINAL TO FACILITATE DRAINAGE

3. ALL HEAVY EQUIPMENT SHALL BE KEPT OFF THE MOUND AREA FOLLOWING CONSTRUCTION. IN ADDITION, NO EQUIPMENT SHALL BE

4. MOUND SHALL BE ELEVATED AS REQUIRED TO PROVIDE A MINIMUM OF 2' OF NATURAL SOIL ABOVE BEDROCK AND A MINIMUM OF 1'

5. THE SLOPE OF THE ORIGINAL GROUND SURFACE IN THE LOCATION OF THE MOUND SHALL NOT EXCEED 12%. THE SYSTEM SHALL BE

NOTE: ASTM C33 WASHED CONCRETE SAND WILL TYPICALLY MEET THE ABOVE SUGGESTED MOUND SAND CRITERIA AND

WILL TYPICALLY BE AVAILABLE AT MOST SAND AND GRAVEL DISTRIBUTORS; HOWEVER, THIS MATERIAL WILL OFTEN HAVE A PERC RATE

FASTER THAN THE MINIMUM OF 5 MINUTES PER INCH. THE PERCOLATION RATE SHALL BE VERIFIED AND TAKE PRECEDENCE TO THE FILL


GRADATION REQUIREMENTS WHEN A MOUND IS PLACED OVER VERY SLOW PERCOLATING SOIL TO AVOID RAPID WEEPING OF FLUIDS

7. THE NATURAL VEGETATION SHALL NOT BE SCRAPED AWAY WITH THE EXCEPTION OF TREES, STUMPS AND EXCESSIVE VEGETATION. THE

PROPOSED MOUND AREA SHALL BE PLOWED TO A DEPTH OF 7" - 8" PREFERABLY WITH A DOUBLE-BOTTOM BLADE/FURROW PLOW WITH

TURNED UPSLOPE OR A BACKHOE EQUIPPED WITH PLOWING BLADES. ALL TRAFFIC SHALL BE EXCLUDED FROM THE MOUND AREA


8. DEPENDING ON DEPTH OF HIGH WATER MARK OR BEDROCK, THE ENTIRE MOUND MAY BE ADJUSTED UP OR DOWN. ALL REQUIRED CLEARANCES AND MINIMUM SLOPES MUST BE MAINTAINED. IF ADJUSTMENTS ARE MADE TO THE MOUND, THE ENGINEER SHALL BE

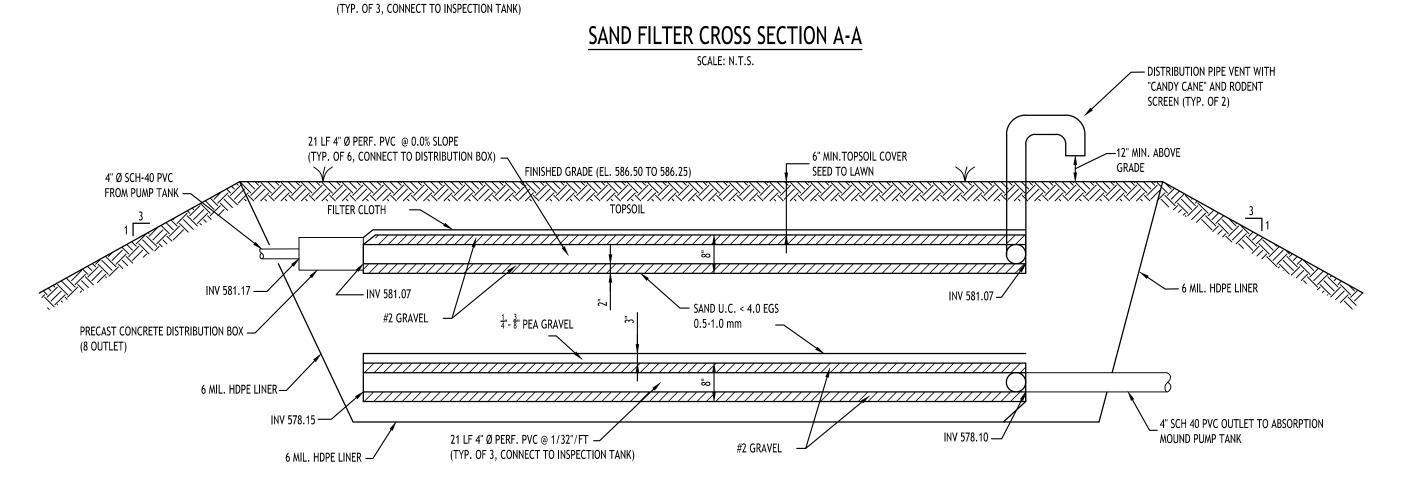

SAND FILTER SECTION B-B SCALE: N.T.S.

DISTRIBUTION BOX 4" Ø SCH-40 PVC / FROM PUMP TANK INV IN 585.16-(3) 4" DISTRIBUTION LINES @ 7.5' OC; 20' LF. @ 0.0% SLOPE (LEVEL) 6" TOPSOIL LAYER OVER ABSORPTION BED SAND -(PERC RATE 5-30 MIN./IN); 6" DEPTH UNDER DISTR. LINE GRAVEL


MOUND PLAN SIZING CALCUALTION: DAILY FLOW = 450 GPD SCALE: NTS PERC RATE OF EX. UNDERLYING SOIL : > 60 MIN. APPLICATION RATE BASED ON PERC. RATE = 1 GPD/SF BASAL AREA REQ'D = 450 GPD / 1 GPD/SF = 450 SF BASAL AREA PROVIDED = 450 SF

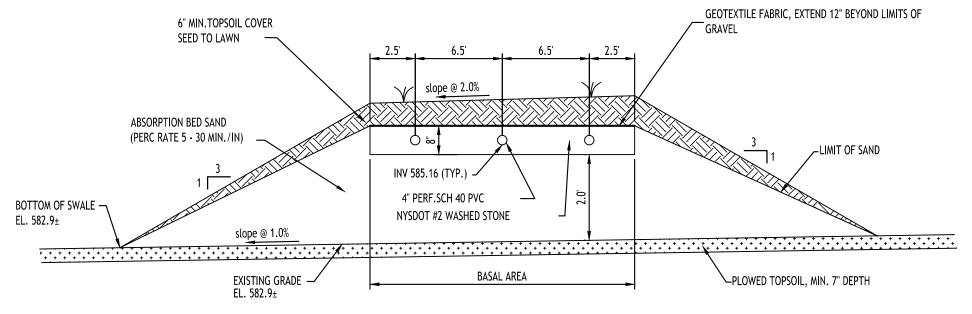

The absorption bed sand shall meet the following criteria: 1. < 10% passing #200 sieve 2. => 25% between 0.5 mm to 2.0 mm

3. Percolation rate of between 5 - 30 min/inch

MOUND SECTION B-B

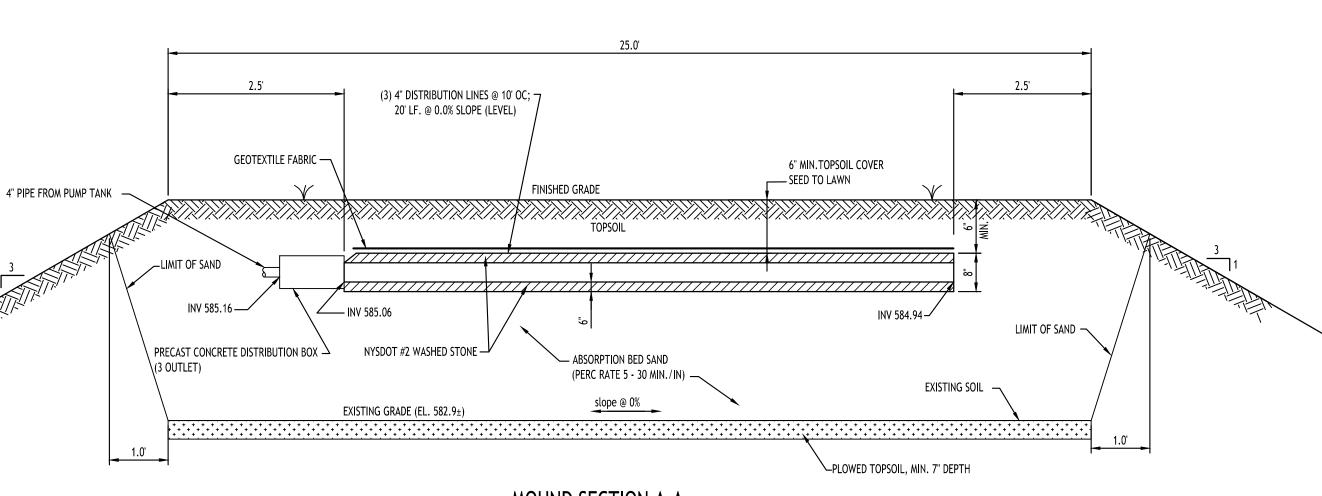

MOUND SECTION A-A SCALE: N.T.S.

DRAWING NAME: **Utility Details**

TOWN OF AMHERST APPROVAL BOX:

Drawn By: Scale:

DRAWING NO.


11/19/24


C. Wood


As Noted

Ë

 $\mathbf{\Omega}$

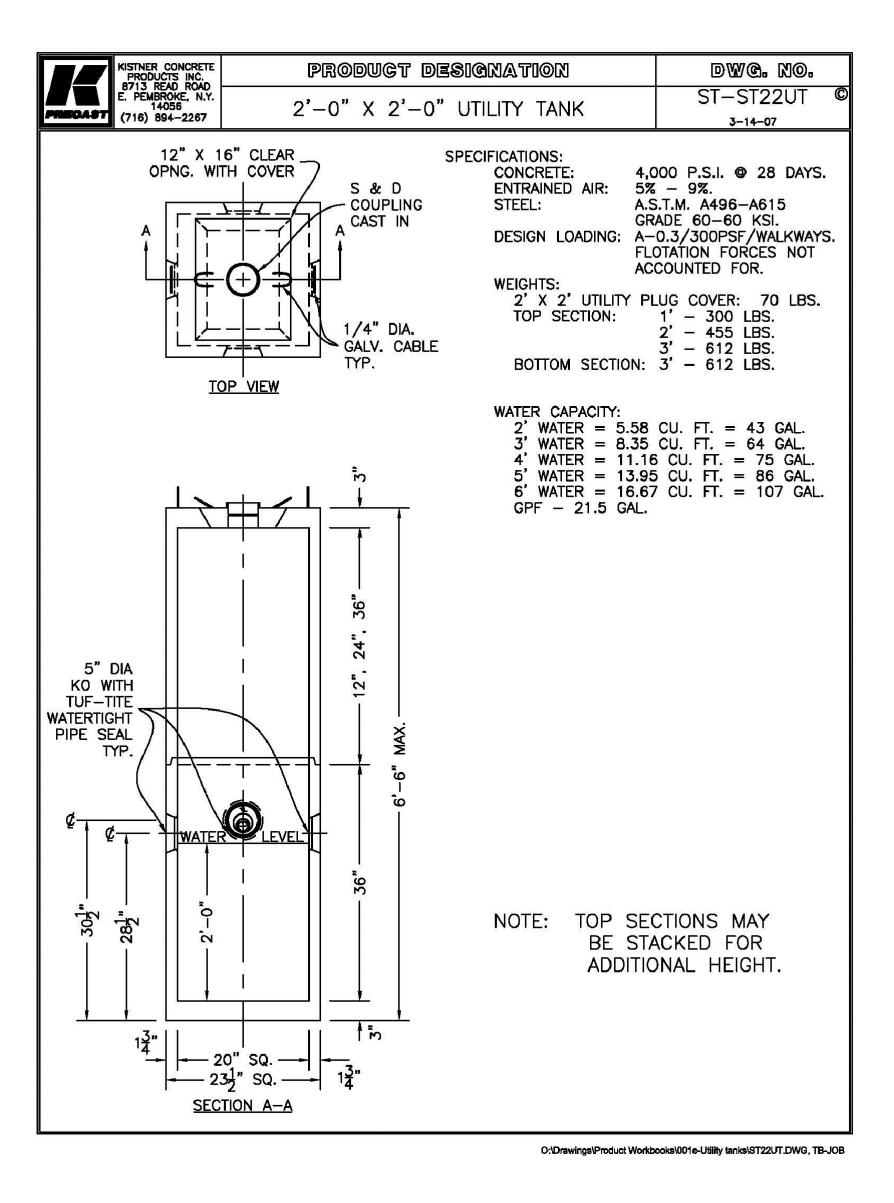

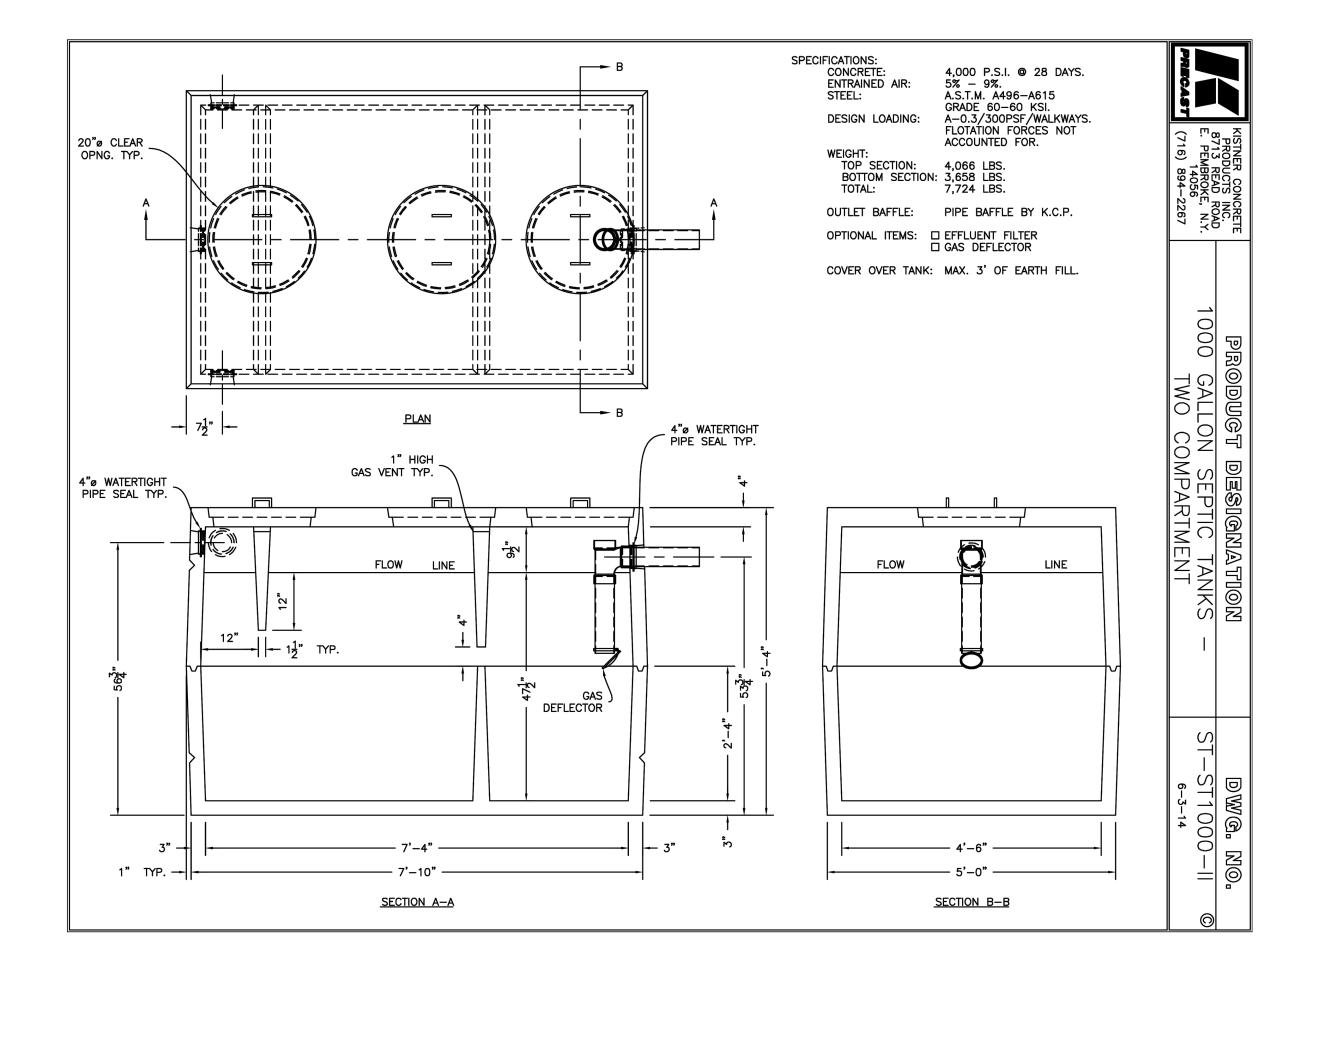

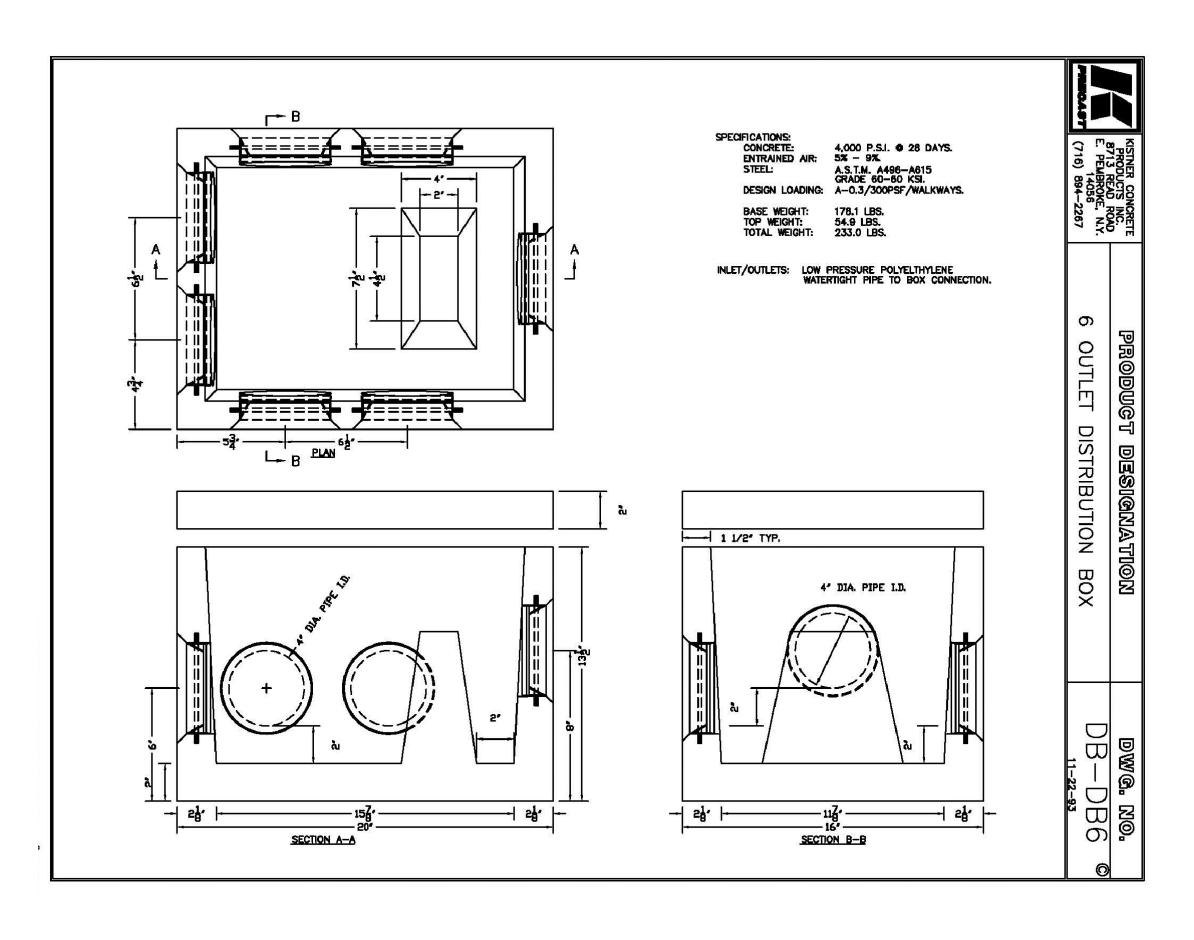

TOWN OF AMHERST APPROVAL BOX:

DRAWING NAME:

Ġ

Uil

 $\mathbf{\Omega}$

eho

Utility Details

Drawn By:

DRAWING NO.

11/19/24 C. Wood

__6" TOPSOIL (MIN.) 1'-6" BELOW FINISHED GRADE TOP OF PIPE ZONE


A. PIPE INSTALLATION SHALL BE IN ACCORDANCE WITH MANUFACTURERS RECOMMENDATIONS.

- B. TRENCHING OPERATIONS SHALL INCLUDE ALL NECESSARY DEWATERING.
- C. TRENCH DETAILS ARE ONLY SHOWN FOR PURPOSES OF MATERIAL PLACEMENT AND MAXIMUM PAY LIMITS.
- D. AN OSHA APPROVED MOVABLE PROTECTIVE TRENCH SHIELD SHALL BE USED IN ALL UNSHEETED TRENCH AREAS.

PIPE BEDDING MATERIAL (NYSDOT 1985 EDITION)


- (1) NO. 1 CRUSHED STONE OR CRUSHED GRAVEL WITH A GRADATION CONFORMING WITH NYSDOT SECTION 703-02. THE MATERIAL SHALL BE WELL GRADED WITH NO PARTICLES LARGER THAN ONE INCH AND HAVING A MAXIMUM GRADATION MEETING THE LIMITS DESCRIBED IN THE SPECIFICATIONS. THE BEDDING SHALL BE COMPACTED IN 6" LIFTS WITH EQUIPMENT ACCEPTABLE TO THE PIPE
 - NO SLAG SHALL BE ALLOWED FOR MATERIAL
- (2) BACKFILL MATERIAL SHALL BE NATIVE SOIL CONTAINING NO UNSUITABLE MATERIAL COMPACTED IN 6" LIFTS.

SEWER/WATERLINE TRENCH SECTION IN UNPAVED AREAS

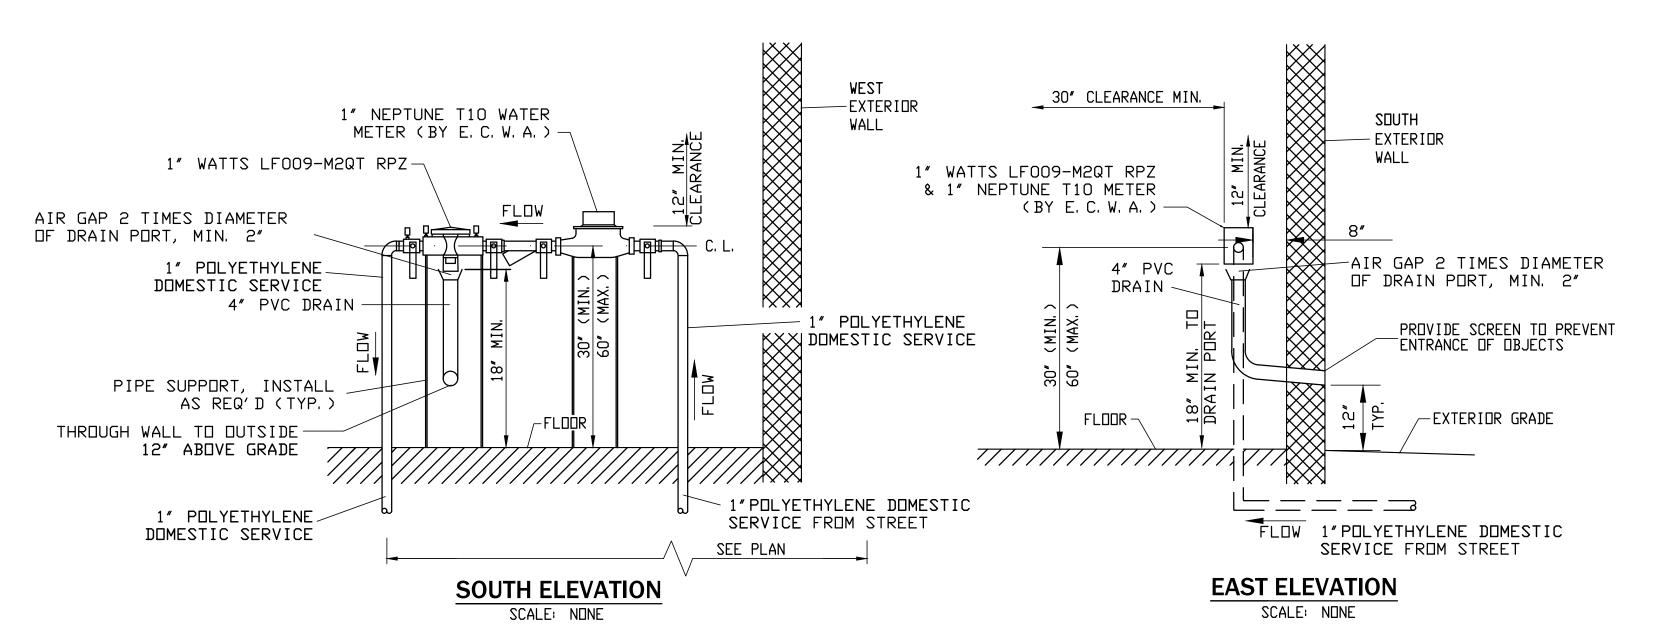

1.5" DOMESTIC SERVICE BACKFLOW PREVENTER **INSTALLATION**

1. NO TAPS TO BE MADE UPSTREAM OF RPZ & METER. HEAT, LIGHT AND ELECTRIC TO BE PROVIDED AT RPZ LOCATION. 3. COORDINATE LOCATION WITH ARCHITECTURAL PLANS.

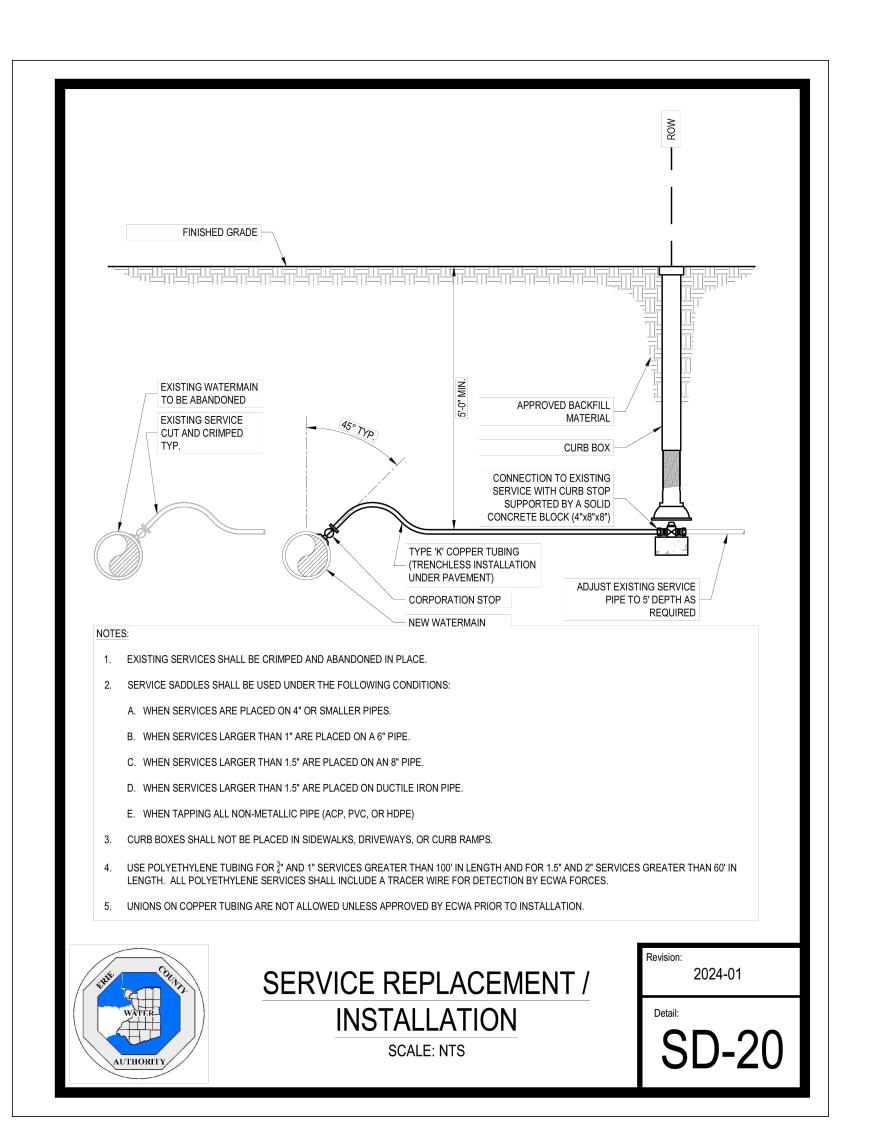

B

TOWN OF AMHERST APPROVAL BOX:

DRAWING NAME: **Utility Details**

> Drawn By: Scale: DRAWING NO.

11/19/24 C. Wood

As Noted

<u>Project No:</u> 24.4019

Building


rehous


C. Wood

As Noted

Date: 11/19/24 Drawn By: Scale: DRAWING NO.

TYPICAL COMMERCIAL SERVICE WITHOUT BASEMENT DETAIL

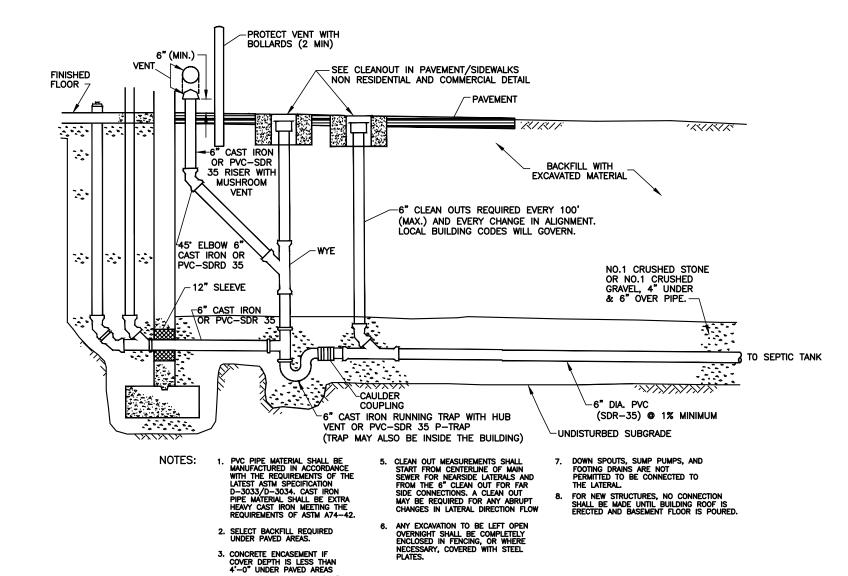

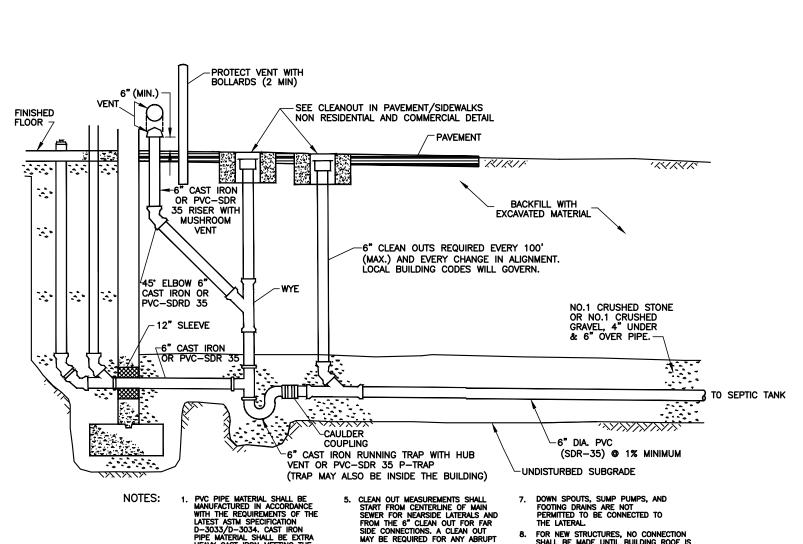

- EXPANSION JOINT

WITH FIBERBOARD

— 6" FOR IN-LINE CLEAN-OUT 8" FOR END OF LINE LAMPHOLE

- 4000 PSI CONCRETE ENCASE TO FULL DEPTH OF FRAME

- SEE PLANS FOR SEWER SIZES FRAME OD + 2' LAMPHOLE/CLEANOUT IN PAVEMENT/SIDEWALK

NOT TO SCALE

EXTERIOR CLEANOUT @ GRADE —— J.R. SMITH #4251-U W/ VANDAL-

PROOF SCREWS OR APPROVED EQUAL


TOP COURSE

BINDER

STONE BASE

SELECT FILL


FLOW —

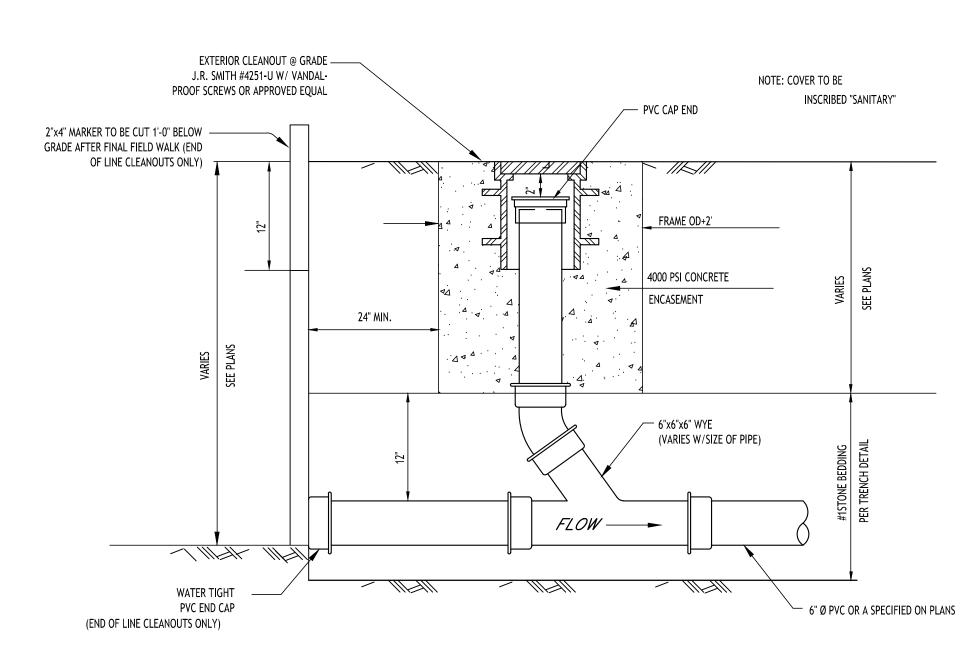

LAMPHOLE/CLEANOUT IN LAWN/FIELD AREAS

NOT TO SCALE

TOWN OF AMHERST APPROVAL BOX:

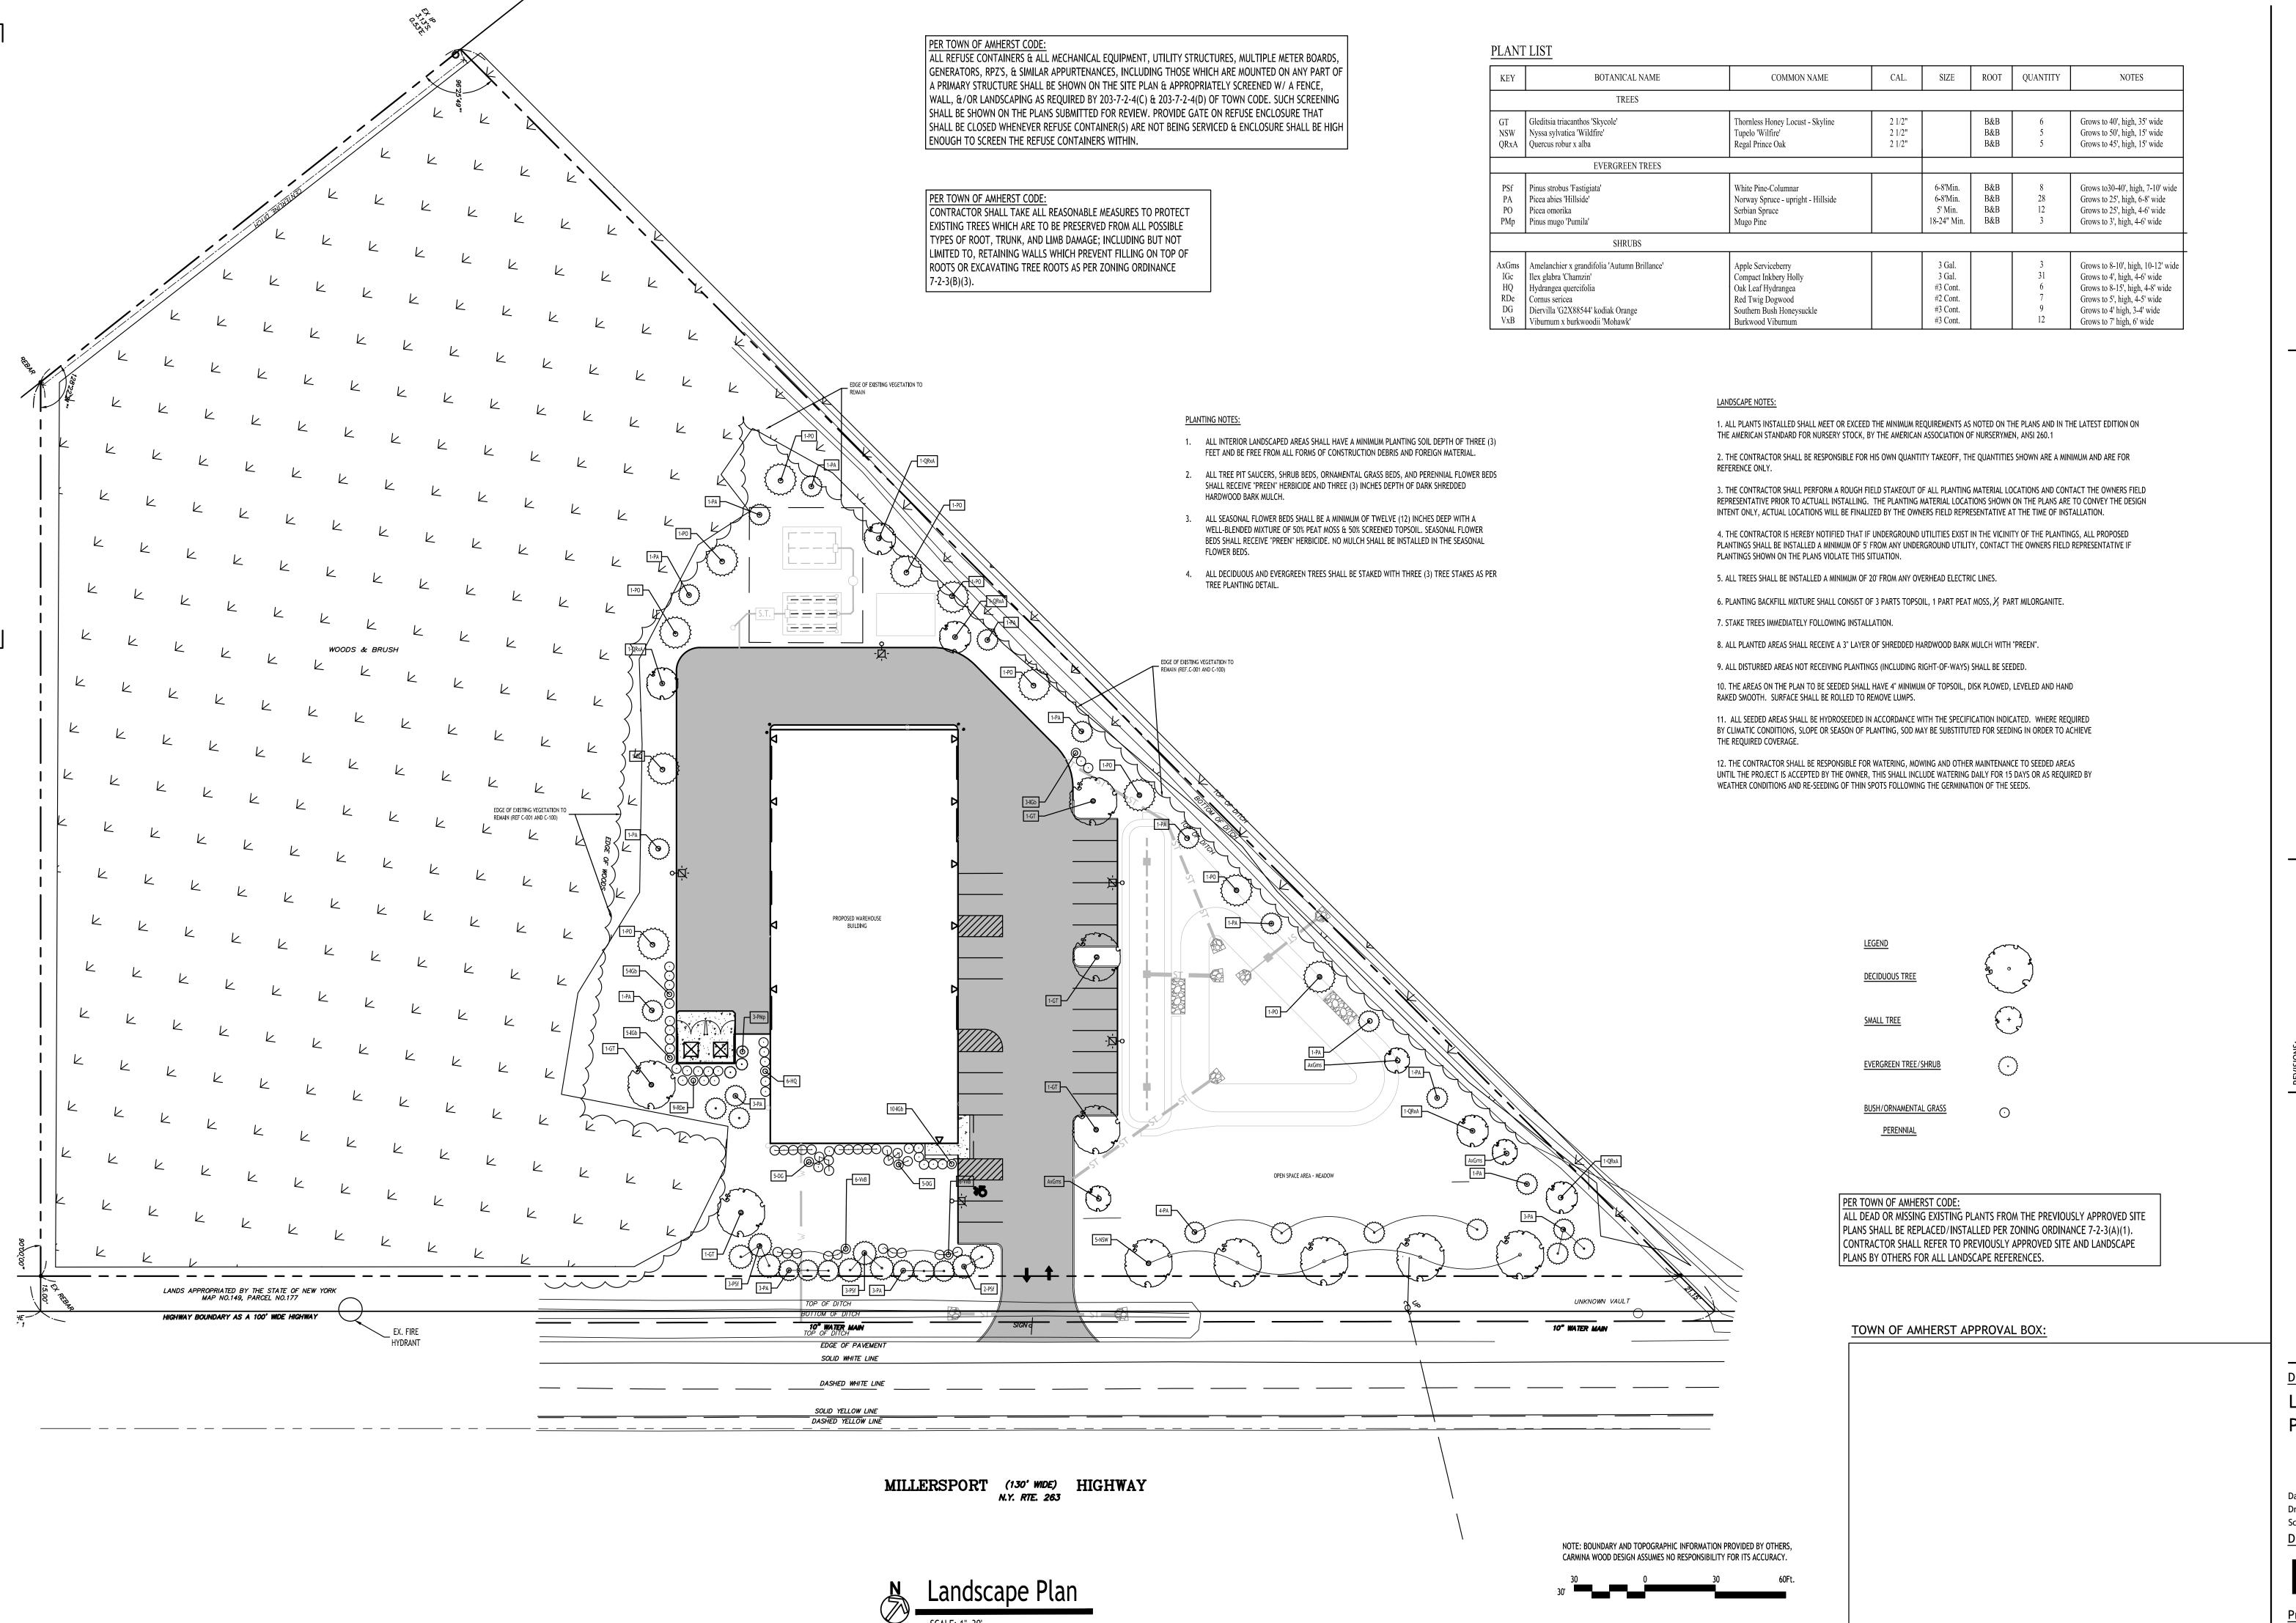

MINAWOO DESIGN

use Building | CAR

Proposed Wareho

No. Description

Another Date

DRAWING NAME:

Landscape


Date: Drawn By: Scale:


Scale:


DRAWING NO.

11/19/24 C. Wood


.-100

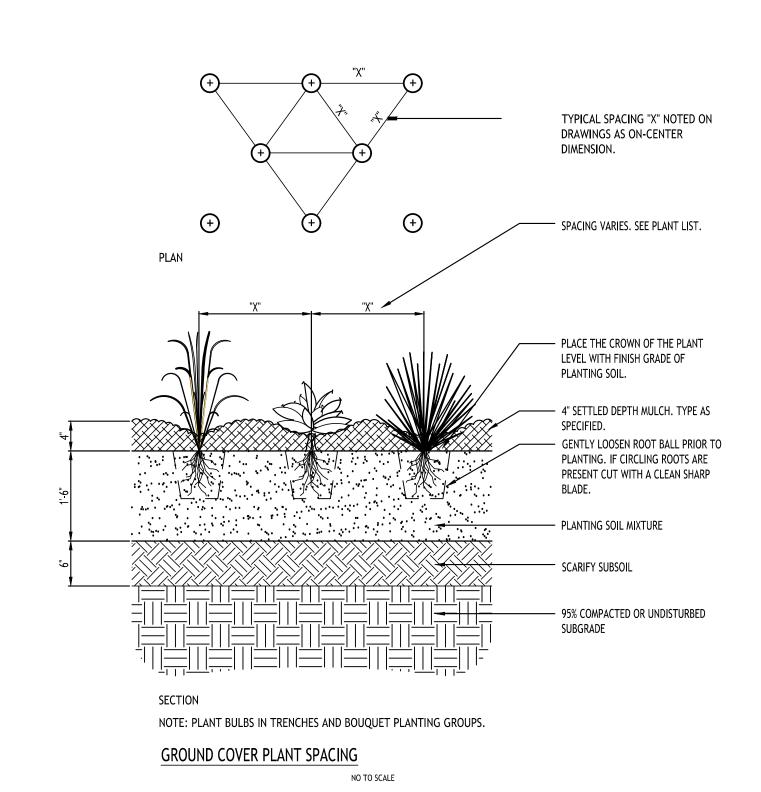


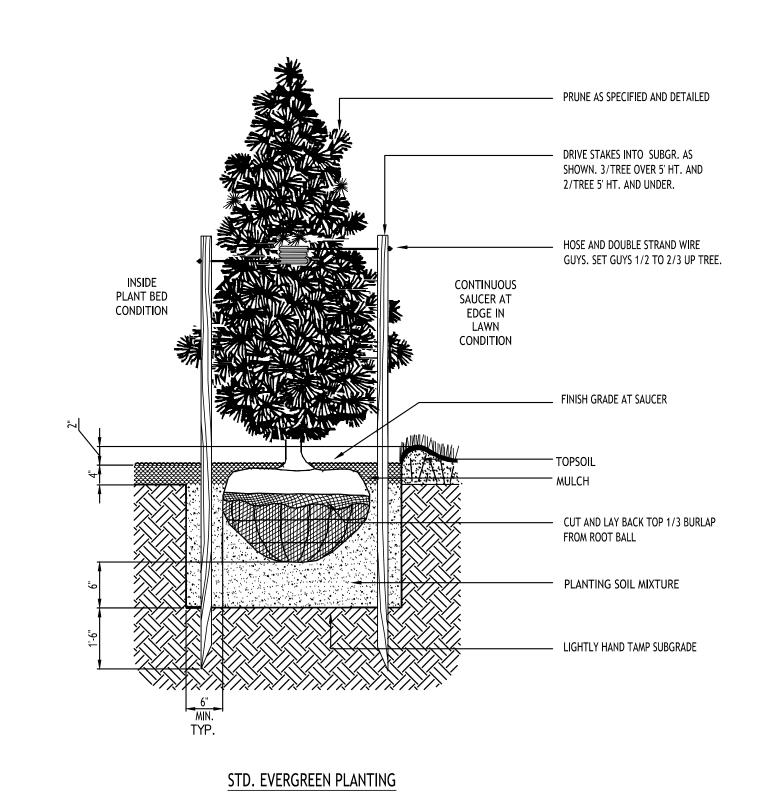


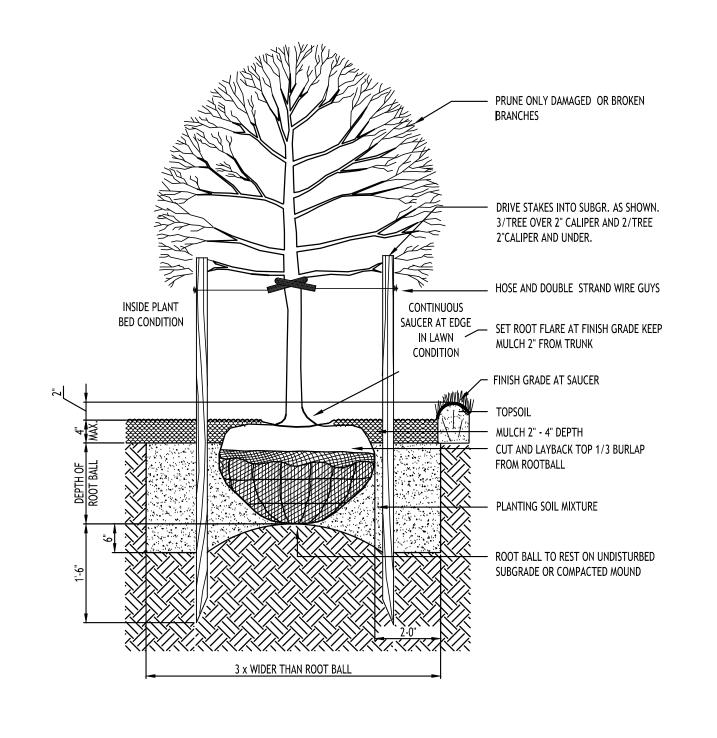



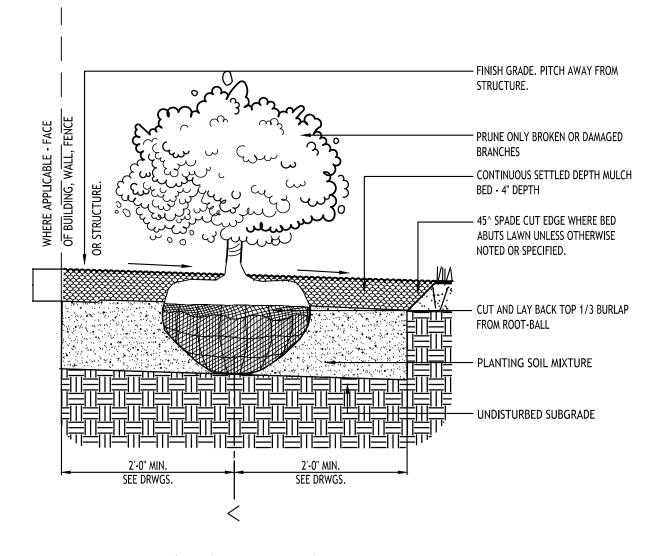

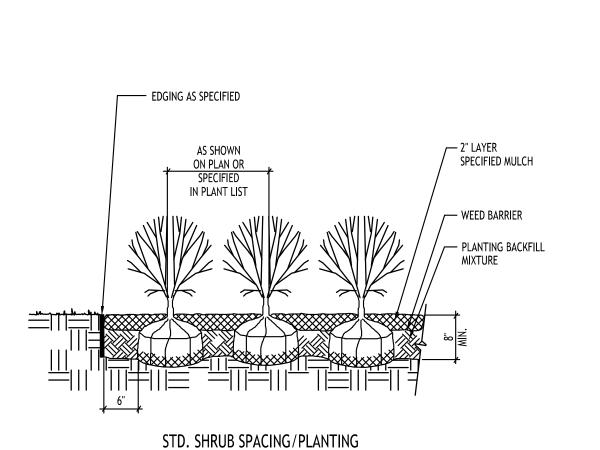

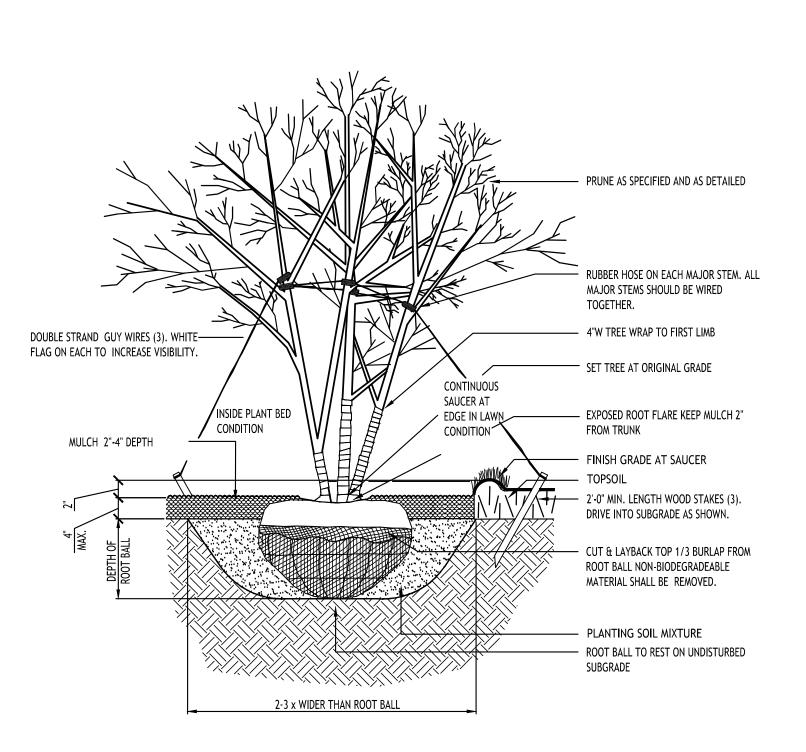

STD. MULTI STEM DECIDUOUS TREE PLANTING

TOWN OF AMHERST APPROVAL BOX:

DRAWING NAME: Landscape Details

D

 $\mathbf{\Omega}$


0


Date:


<u>Project No:</u> 24.4019

C. Wood Drawn By: As Noted Scale: DRAWING NO.

11/19/24

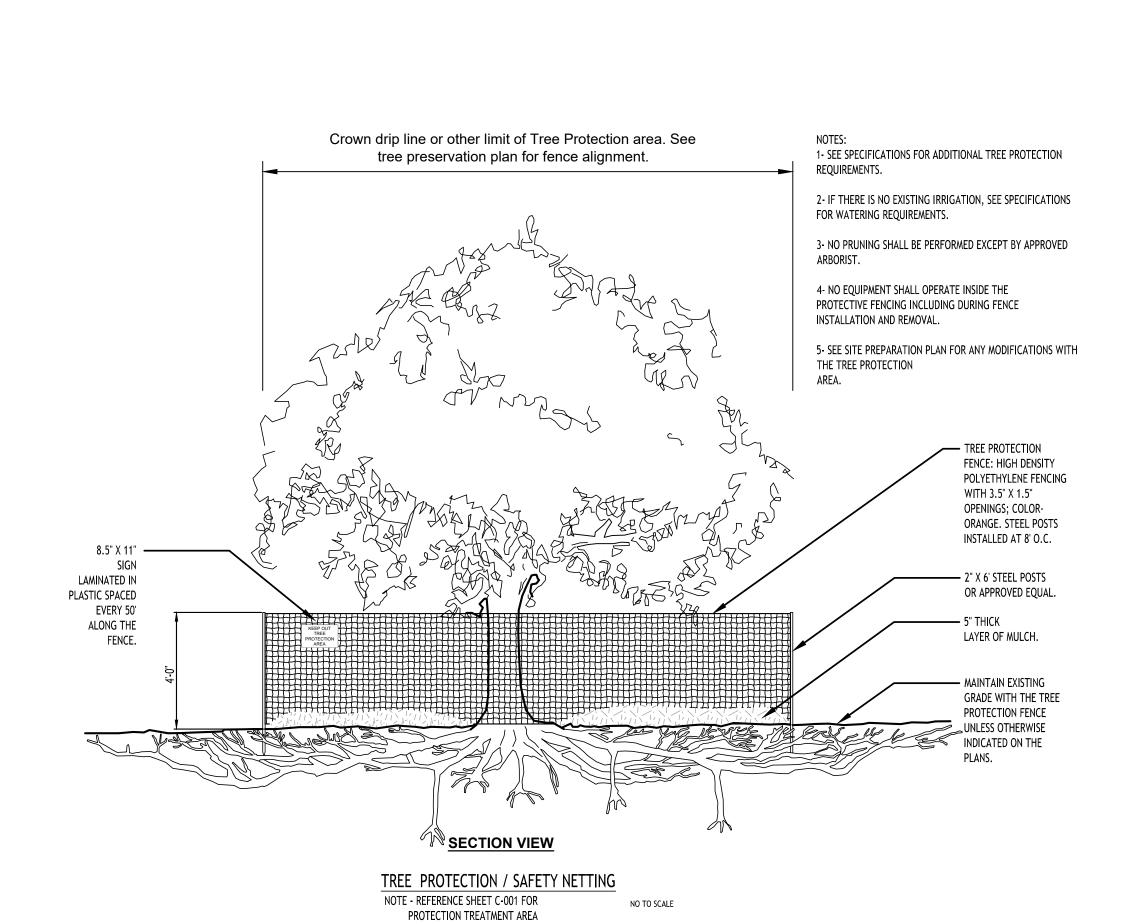

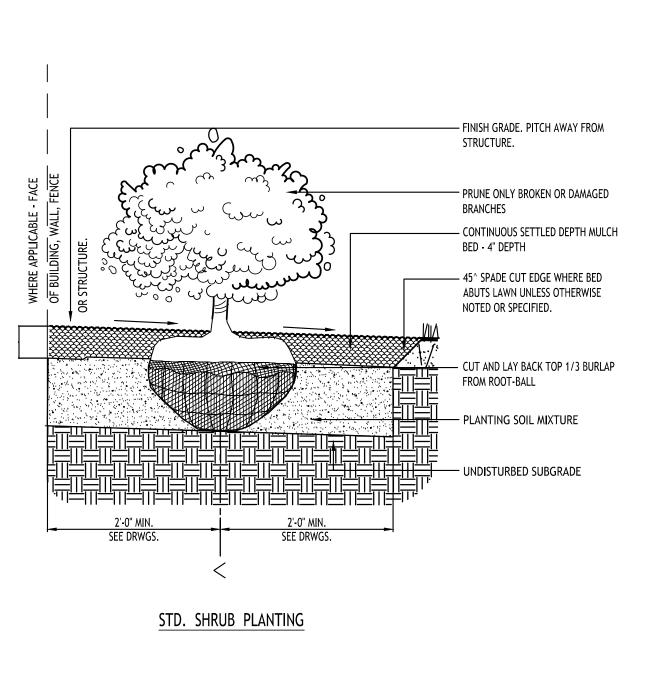

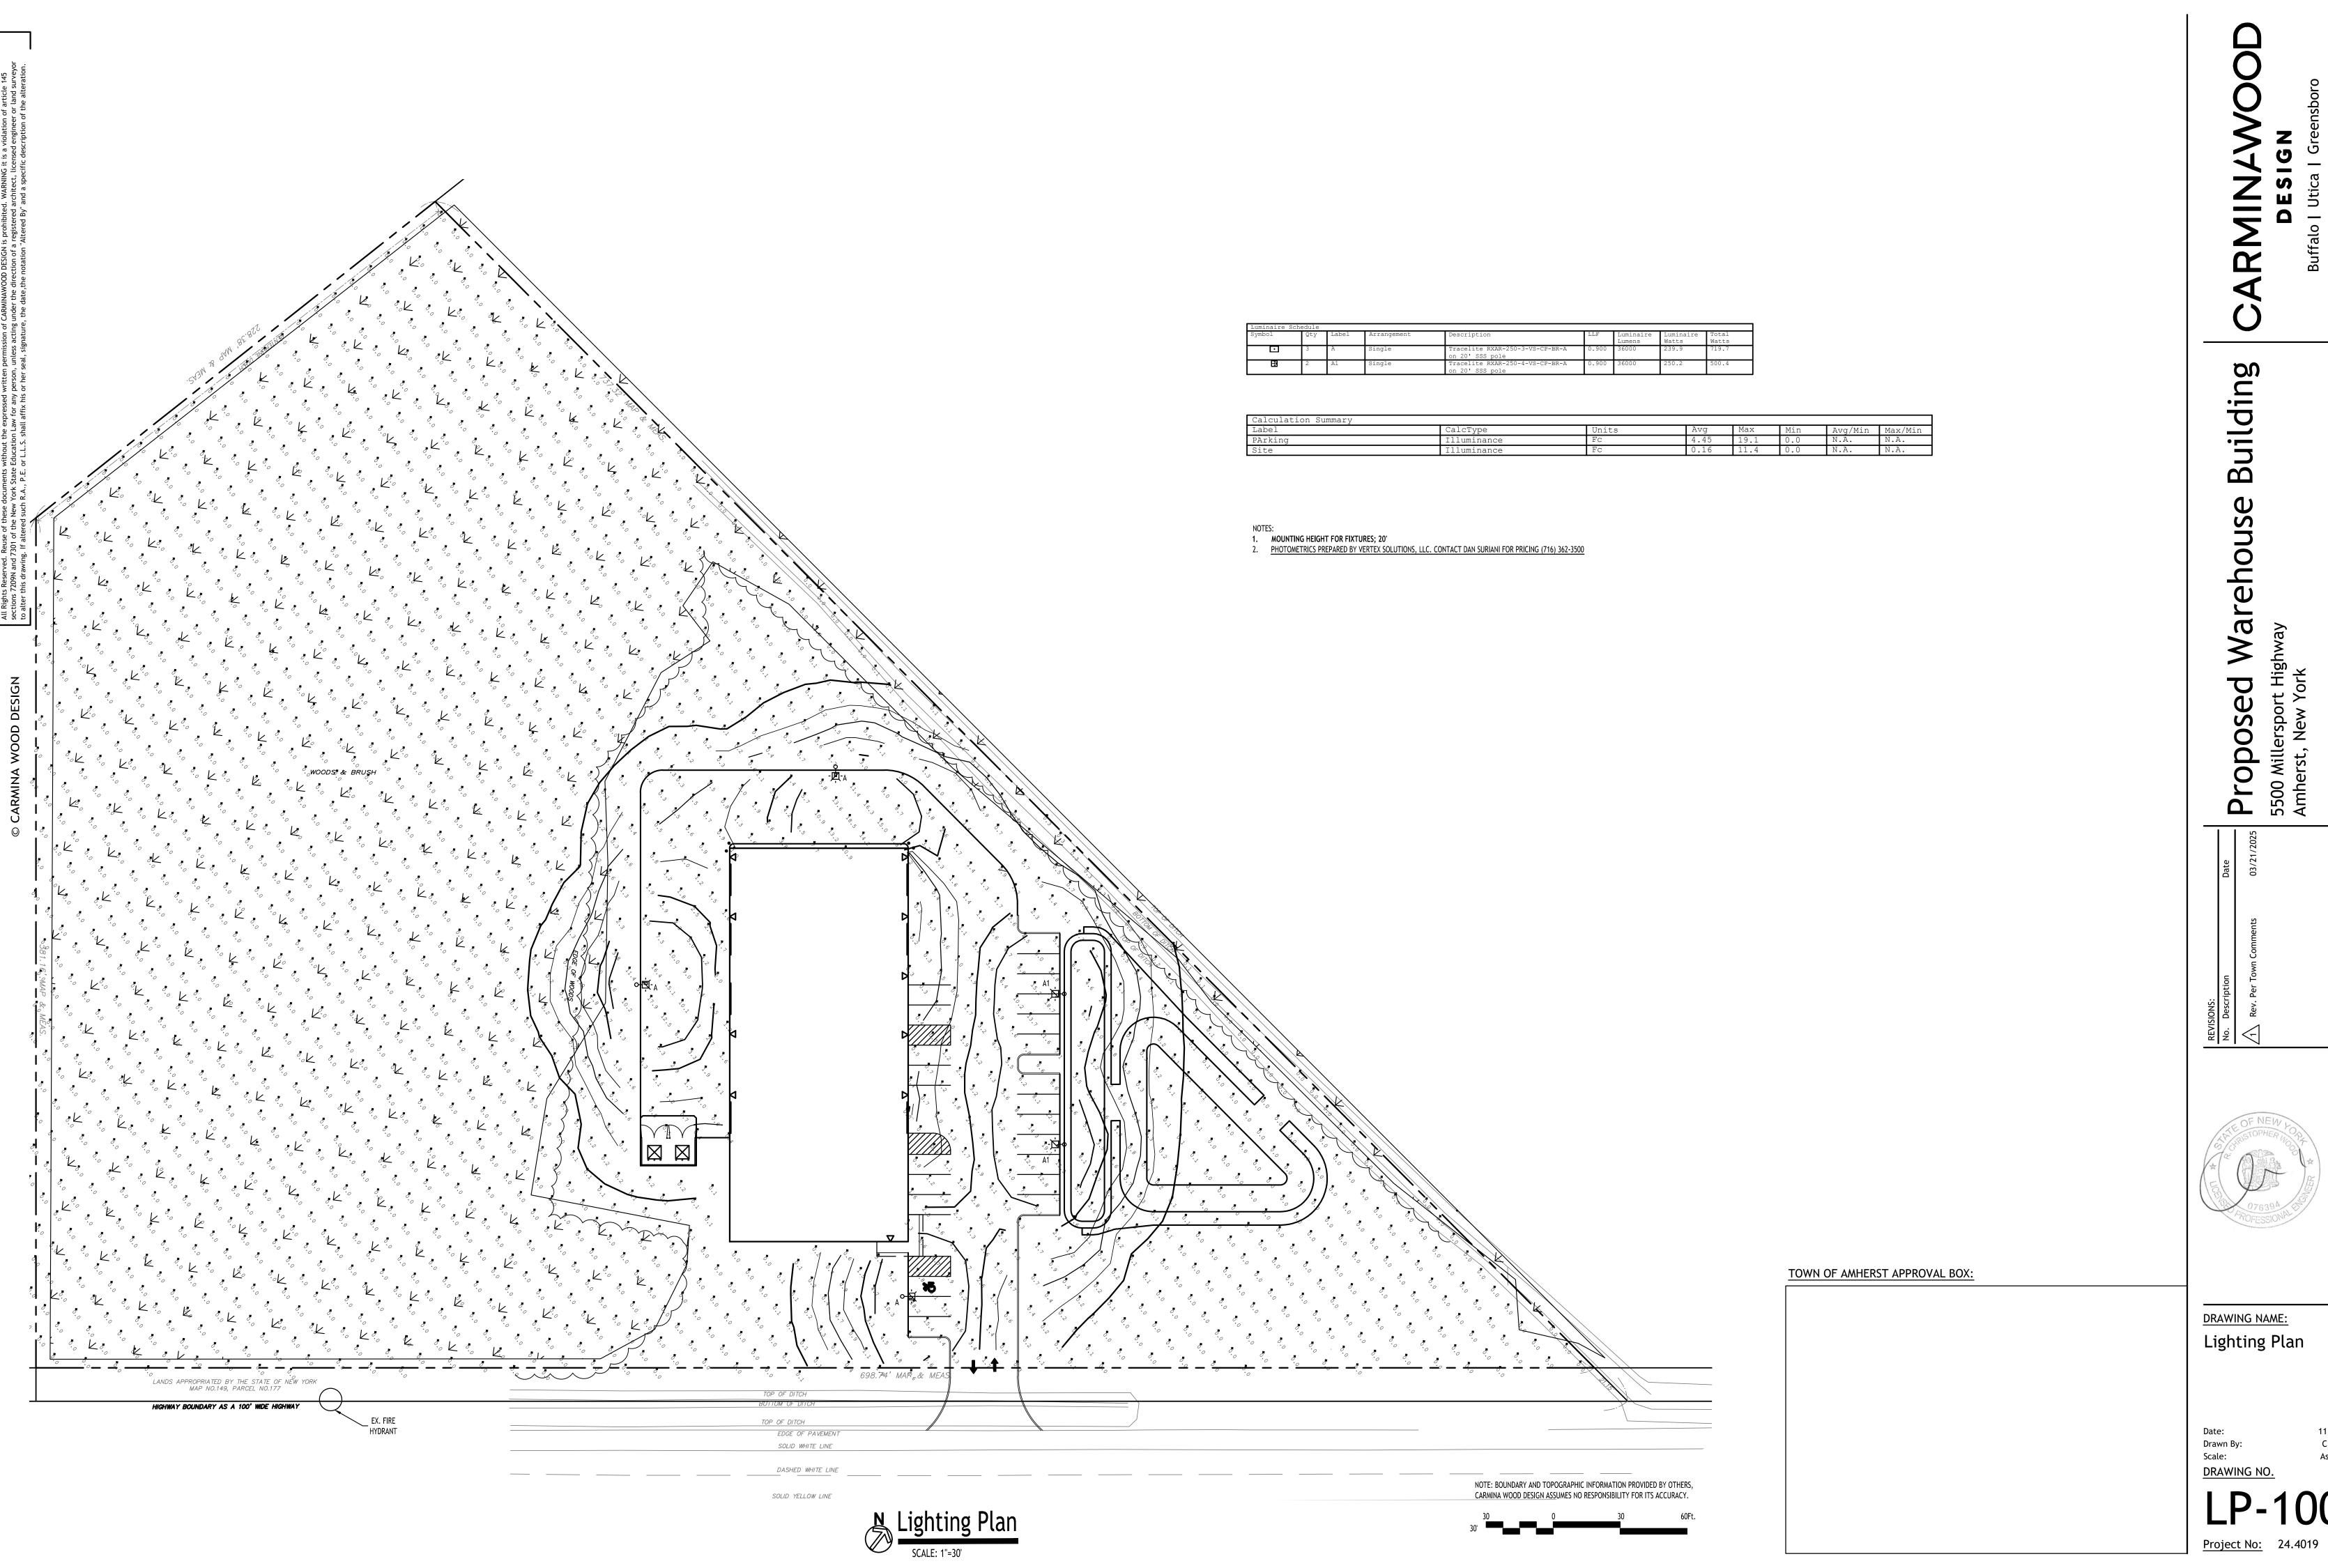



DRAWING NAME:

Lighting Plan

11/19/24 C. Wood As Noted

TRACE*LITE°

The RXAR Series LED area luminaire offers performance and durability with a rugged, one-piece die-cast aluminum housing and high efficacy of up to 172 lumens per watt. This versatile luminaire is designed to ensure optimal heat dissipation and energy efficiency, guaranteeing longevity and reliability. It is available in Type II, III, IV, and V distributions to cater to diverse lighting needs while maintaining zero uplight to eliminate light pollution. With field switchable power (6,200 to 60,000 lumens), and CCT (3000K-4000K-5000K, depending on model) the RXAR Series offers unparalleled flexibility. Includes straight arm for mounting to 4" and 5" square or round pole standard in the packaging. Several other mounts, shields and accessories are available for maximum

SPECIFICATIONS Construction:

• Sleek die-cast aluminum housing with stainless steel hardware and powder coated finish Integral heat sink fins maximize heat dissipation Hinged driver access door for ease of maintenance

• Straight arm for 4" and 5" square or round pole included standard, other • Slotted bolt pattern suitable for retrofit to most existing drill hole patterns • Includes a 12" whip (5 conductors provided for convenience, dimming leads not connected)

Optics/LEDs: • 40 to 400 Watts with lumen packages up to 60,000 lumens • Designed with zero uplight to eliminate light pollution • Efficacies up to 172 LPW maximize energy savings and utility rebates • Type II, III, IV and V distributions optimize light distribution

· Hinged driver door for ease of access (coin plugs on the driver door provide ease of access to dipswitches for power and CCT selectability) • Standard with pole mount arm suitable for 4" or 5" square or round poles. Arm features access door for easy wiring on site • Additional contractor friendly mounts such as slipfitter, trunnion, swivel, adjustable pole mount, and wall bracket

 Five Year Warranty (Terms and Conditions Apply) • 10 Year Warranty available upon request, consult factory

• 120-277VAC 3-Pin Twist Lock receptacle (option TLPC) (Twist Lock • 120-277VAC 7-Pin Twist Lock receptacle (option TLPC3) (Twist Lock • 347-480VAC 3-Pin Twist Lock Receptacle (option TLPC4) (Twist Lock photocontrol included)

Specifications are subject to change without notice. Installation must be performed in accordance with Barron Lighting Group installation instructions.

RXAR Series

Accessories:

Type II, III, IV and V distributions optimize light distribution	CERTIFIED	JM W	To Belling Bank Polling	logic		WANNANI
 Easily field switchable between 3000K, 4000K and 5000K CCT (4000K and 5000K for 400W models) 						
• L70 of >100,000 hours	Specs at a Glan	ce				
• L90 of 40,000 hours	Model	RXAR-100	RXAR-140	RXAR-250	RXAR-300	RXAR-400
• CRI ≥80 Electrical:	Wattage*	40W-60W- 80W-100W	60W-90W- 120W-140W	100W-150W- 200W-250W	120W-180W- 240W-300W	300W-320W- 360W-400W
• Class 2 power supply, 120-277VAC, 50/60Hz		(Switchable)	(Switchable)	(Switchable)	(Switchable)	(Switchable)
0-10V Dimming driver Power Factor ≥ 0.90	Lumens (Im)	6,400 - 16,000	9,600 - 23,000	14,500 - 38,000	18,000 - 46,000	46,000 - 60,000
277-480VAC Dedicated driver option	Efficacy (LPW)	up to 170	up to 172	up to 161	up to 169	up to 167
 10KA(@120-277V) or 20KA(@347-480V) surge protection 	Distribution	tion Type II, III, IV, V				
Testing & Compliance: • cULus Listed for Wet Locations, tested to meet IP65 requirements	сст (К)	3000K-4000K-5000K (Switchable)			4000K-5000k (Switchable)	
 DesignLights Consortium® (DLC) PREMIUM Qualified (consult QPL for qualified models) 	CRI	>80				
• Operating temperature: -40°C to 45°C (-40°F to 113°F), -40°C to 40°C (-40°F	Input Voltage	120-277VAC or 277-480VAC				
to 104°F) for the 400W model • 3G Vibration rated enclosure	Operating Temp		-40°C	to 45°C		-40°C to 40°C
International Dark Sky friendly approved product. (IDA) (compliant onlywith a	Certifications	UL Listed for Wet Locations, IP65, DLC PREMIUM				
fixed downlight mount) and with factory installed RXAR-DSFA module locking	Warranty	5 Years				
CCT to 3000K	Weight	12.0 lbs	12.4 lbs	17.4 lbs	18.0 lbs	18.5 lbs
Installation: • Hinged driver door for ease of access (coin plugs on the driver door provides ease of access to dipswitches for power and CCT selectability)	* Nominal Wattage. To See performance tal				on.	1

Note: Environment and application will affect actual performance. Typical values and 25°C used for testing. Factory Installed Accessories • Factory installed module to lock CCT to 3000K for Dark Sky IDA compliance (RXAR-DSFA)

• 3-Pin Twist Lock universal photocontrol (120-277VAC) for dusk to dawn lighting control • 3-Pin Twist Lock universal photocontrol (347-480VAC) for dusk to dawn lighting control

• 7-Pin Twist Lock universal photocontrol (120-277VAC) for dusk to dawn lighting control • Bluetooth enabled dimming occupancy sensor (<u>LE-MS3W-BL-AUX-HB1</u>), PIR, 120/277VAC • Dimming occupancy sensor (TL-MSP12-BL), PIR, with photocontrol, 120/277VAC • Multiple contractor friendly mounts and accessories available, see ordering information

Page 1 of 7

Wattage, Size **LED Area Light**

TLPR = 120-277VAC 3-Pin Twist Lock Photocontrol and Receptacle

¹ 70 CRI only, longer lead times may apply, consult factory

TLPR7 = 120-277VAC 7-Pin Twist Lock Photocontrol and Receptacle

TLPRH = 347-480VAC 3-Pin Twist Lock Photocontrol and Receptacle

Ordering Information (Example: RXAR-250-3-VS-CP-BR-A-TLPC) 100 = 40-100W, Small 2 = Type II HVS¹ = 277-480VAC CP² = CCT & Power Switchable BL¹ = Black A = Pole Mount Arm 140 = 60-140W, Small 3 = Type III VS = 120-277VAC BR = Bronze 250 = 100-250W, Large SV1 = Gray Aluminum 4 = Type I 300 = 120-300W, Large WH1 = White 400 = 300-400W, Large Options (Factory Installed) TLPC = 120-277VAC 3-Pin Twist Lock Photocontrol and Receptacle

Accessories (Factory Installed - Order As Separate Line Item) TLPC3 = 120-277VAC 7-Pin Twist Lock Photocontrol and Receptacle ${\sf RXAR-DSFA=Factory\ installed\ module\ to\ lock\ CCT\ to\ 3000K\ CT\ for\ Dark\ Sky\ IDA\ Compliance}$ TLPC4 = 347-480VAC 3-Pin Twist Lock Photocontrol and Receptacle LiteLogic Accessories³ (Field Installed - Order As Separate Line Item) Accessories3 (Field Installed - Order As Separate Line Item) W-BL-AUX-HB1 = Bluetooth PIR Motion Sensor with Photocontrol, Black TL-MSP12-BL = Dimming Occupancy Sensor, PIR, Black Finish RXAR-HSS5 - House Side Shield TL-MSSW-REMOTE = Remote for Sensor

RXAR-APM-XX⁴ = Adjustable Pole Mount Arm (XX = BL; Black, BR; Bronze, SV; Gray Alum, WH; White RXAR-L-FGS-BR = Full Glare Shield, Large, Bronze Finish (250W, 300W, 400W) RXAR-L-GS-BR = Glare Shield, Large, Bronze Finish (250W, 300W, 400W) RXAR-S-FGS-BR = Full Glare Shield, Small, Bronze Finish (100W, 140W) RXAR-S-GS-BR = Glare Shield, Small, Bronze Finish (100W, 140W) RXAR-SF-XX⁴ = Slip fitter Mount (XX = BL; Black, BR; Bronze, SV; Gray Alum, WH; White) 2XAR-WM-XX⁴ = Wall Mount (XX = BL; Black, BR; Bronze, SV; Gray Alum, WH; White) RXAR-SW-XX⁴ = Swivel Mount (XX = BL; Black, BR; Bronze, SV; Gray Alum, WH; White) RXAR-TR-XX⁴ = Trunnion Mount (XX = BL; Black, BR; Bronze, SV; Gray Alum, WH; White) ² 400W Switchable between 4000K/5000K, static 3000K option available - consult factory ³ Order as separate line item - Shipped in separate box for final installation in the field

⁵ Two (2) pieces required for 250W, 300W, and 400W units

⁴ Black (BL), Gray Aluminum (SV), and White (WH) finishes may require longer lead times, consult factory (default finish is bronze)

ADDITIONAL POLE MOUNTS AVAILABLE - SEE PAGES 6-7 FOR DETAILS Sample Photometry RXAR-140-5-VS-CP (140W, 4000K)
IES: TYPE VS SHORT
MOUNTING HEIGHT: 20'
TILT: ZERO MOUNTING HEIGHT: 20' TILT: ZERO

Model	Wattage	ССТ	Distribution	Lumens	LPW	BUG Rating	CRI
RXAR-100-2-VS-CP-BR-A (100W, T2, 4000K)	100W	4000K	Type II	15400lm	154 lm/W	B3-U0-G3	80
RXAR-100-2-VS-CP-BR-A (80W, T2, 4000K)	80W	4000K	Type II	12700lm	159 lm/W	B3-U0-G3	80
RXAR-100-2-VS-CP-BR-A (60W, T2, 4000K)	60W	4000K	Type II	9800lm	163 lm/W	B3-U0-G2	80
RXAR-100-2-VS-CP-BR-A (40W, T2, 4000K)	40W	4000K	Type II	6600lm	165 lm/W	B2-U0-G2	80
RXAR-100-3-VS-CP-BR-A (100W, T3, 4000K)	100W	4000K	Type III	15400lm	154 lm/W	B3-U0-G3	80
RXAR-100-3-VS-CP-BR-A (80W, T3, 4000K)	80W	4000K	Type III	12700lm	159 lm/W	B3-U0-G2	80
RXAR-100-3-VS-CP-BR-A (60W, T3, 4000K)	60W	4000K	Type III	9800lm	163 lm/W	B2-U0-G2	80
RXAR-100-3-VS-CP-BR-A (40W, T3, 4000K)	40W	4000K	Type III	6600lm	165 lm/W	B2-U0-G2	80
RXAR-100-4-VS-CP-BR-A (100W, T4, 4000K)	100W	4000K	Type IV	15400lm	154 lm/W	B3-U0-G2	80
RXAR-100-4-VS-CP-BR-A (80W, T4, 4000K)	80W	4000K	Type IV	12700lm	159 lm/W	B3-U0-G2	80
RXAR-100-4-VS-CP-BR-A (60W, T4, 4000K)	60W	4000K	Type IV	9800lm	163 lm/W	B2-U0-G2	80

Page 2 of 7

Large Glare Shield RXAR-L-GS-BR

(Sold Separately)

RXAR-WM

Allows for Direct Wall Mount

(Sold Separately)

Page 6 of 7

Small Full Glare Shield

RXAR-S-FGS-BR

(Sold Separately)

Trunnion RXAR-TR

RT2-120-3-BR

Bronze finish.

RT2-90-4-BR

Round pole, 120° tenon - 3 arms

Round pole, 90° tenon - 4 arms

Vertical steel tenon adaptor to mount over

a 2-3/8" O.D. round pole, three arms, 120°.

Vertical steel tenon adaptor to mount over a

2-3/8" round pole, four arms, 90°. Bronze finish.

Specifications are subject to change without notice Installation must be performed in accordance with Barron Lighting Group installation instructions. 10810439 Rev 10

House Side Shield

RXAR-HSS

(Sold Separately)

Slipfitter RXAR-SF

For 2-3/8" O.D. Pipe with Angle Markers (Sold Separately)

Pole Top Arms

Shields (sold separately for field installation)

Small Glare Shield

(Sold Separately)

RXAR-SW

Allows Fixture to Swivel and Tilt (180° total tilt, 180° total swivel)

Round pole 90° tenon - 2 arms

Round pole 180° tenon - 2 arms

Round pole 90° tenon - 3 arms

Vertical steel tenon adaptor to mount over a 2-3/8" O.D. round pole, two arms, 90°.

Vertical steel tenon adaptor to mount over

Vertical steel tenon adaptor to mount over a 2-3/8" O.D. round pole, three arms, 90°.

a 2-3/8" O.D. round pole, two arms, 180°.

RT2-90-2-BR

Bronze finish.

RT2-180-2-BR

Bronze finish.

RT2-90-3-BR

Mounting (non-standard mounts sold separately for field installation)

RXAR-S-GS-BR

BARRON lighting group 800.533.3948 • www.barronltg.com

Large Full Glare Shield

RXAR-L-FGS-BR

Adjustable Pole Mount

Adjustable Between 90° Up and

90° Down with Angle Markers

RXAR-APM

(Sold Separately

RXAR-100-4-VS-CP-BR-A (40W, T4, 4000K) RXAR-100-5-VS-CP-BR-A (100W, T5, 4000K) RXAR-100-5-VS-CP-BR-A (80W, T5, 4000K) RXAR-100-5-VS-CP-BR-A (60W, T5, 4000K) B3-U0-G2 RXAR-100-5-VS-CP-BR-A (40W, T5, 4000K) 170 lm/W RXAR-140-2-VS-CP-BR-A (140W, T2, 4000K) RXAR-140-2-VS-CP-BR-A (120W, T2, 4000K) RXAR-140-2-VS-CP-BR-A (90W, T2, 4000K) 164 lm/W RXAR-140-2-VS-CP-BR-A (60W T2 4000K) RXAR-140-3-VS-CP-BR-A (140W, T3, 4000K) RXAR-140-3-VS-CP-BR-A (90W, T3, 4000K) 14800lm B3-U0-G3 RXAR-140-3-VS-CP-BR-A (60W T3 4000K) RXAR-140-4-VS-CP-BR-A (140W, T4, 4000K) 160 lm/W B3-U0-G3 RXAR-140-4-VS-CP-BR-A (120W, T4, 4000K) 163 lm/W B3-U0-G3 RXAR-140-4-VS-CP-BR-A (90W, T4, 4000K) RXAR-140-4-VS-CP-BR-A (60W, T4, 4000K) RXAR-140-5-VS-CP-BR-A (140W, T5, 4000K) RXAR-140-5-VS-CP-BR-A (120W, T5, 4000K) RXAR-140-5-VS-CP-BR-A (90W, T5, 4000K) RXAR-140-5-VS-CP-BR-A (60W, T5, 4000K) RXAR-250-2-VS-CP-BR-A (250W, T2, 4000K) RXAR-250-2-VS-CP-BR-A (200W, T2, 4000K) RXAR-250-2-VS-CP-RR-A (150W, T2, 4000K) B3-U0-G3 RXAR-250-2-VS-CP-BR-A (100W, T2, 4000K) 156 lm/W B3-U0-G3 RXAR-250-3-VS-CP-BR-A (250W, T3, 4000K) RXAR-250-3-VS-CP-BR-A (150W, T3, 4000K) RXAR-250-3-VS-CP-BR-A (100W, T3, 4000K) 156 lm/W B3-U0-G3 RXAR-250-4-VS-CP-BR-A (250W, T4, 4000K) 144 lm/W B4-U0-G4 RXAR-250-4-VS-CP-BR-A (200W, T4, 4000K) RXAR-250-4-VS-CP-BR-A (100W, T4, 4000K) RXAR-250-5-VS-CP-BR-A (250W, T5, 4000K) 148 lm/W B5-U0-G3 4000K RXAR-250-5-VS-CP-BR-A (200W, T5, 4000K) 151 lm/W B5-U0-G3 RXAR-250-5-VS-CP-BR-A (150W, T5, 4000K) 155 lm/W B4-U0-G2 RXAR-300-2-VS-CP-BR-A (300W, T2, 4000K) RXAR-300-2-VS-CP-BR-A (240W, T2, 4000K) 240W B4-U0-G4 RXAR-300-2-VS-CP-BR-A (180W, T2, 4000K) RXAR-300-2-VS-CP-BR-A (120W, T2, 4000K) RXAR-300-3-VS-CP-BR-A (300W, T3, 4000K) RXAR-300-3-VS-CP-BR-A (180W, T3, 4000K) RXAR-300-3-VS-CP-BR-A (120W, T3, 4000K) 4000K 19600lm 163 lm/W B3-U0-G3 RXAR-300-4-VS-CP-BR-A (300W, T4, 4000K) 300W 4000K 43800lm 146 lm/W B4-U0-G4 RXAR-300-4-VS-CP-BR-A (240W, T4, 4000K) B4-U0-G4 RXAR-300-4-VS-CP-BR-A (120W, T4, 4000K) 120W 4000K 19600lm 163 lm/W B3-U0-G3 4000K RXAR-300-5-VS-CP-BR-A (300W, T5, 4000K) 300W Type V 44700lm 149 lm/W B5-U0-G4 RXAR-300-5-VS-CP-BR-A (240W, T5, 4000K) 240W 4000K Type V 154 lm/W B5-U0-G3

Specifications are subject to change without notice Installation must be performed in accordance with Barron Lighting Group installation instructions. 10810439 Rev 10

Performance Table (continued)

BARRON lighting group 800.533.3948 • www.barronltg.com

BARRON

800.533.3948 • www.barronltg.com


RXAR-300-5-VS-CP-BR-A (120W, T5, 4000K) RXAR-400-2-VS-CP-BR-A (400W, T2, 4000K) RXAR-400-2-VS-CP-BR-A (360W, T2, 4000K) RXAR-400-2-VS-CP-BR-A (325W, T2, 4000K) RXAR-400-2-VS-CP-BR-A (300W, T2, 4000K) 300W RXAR-400-3-VS-CP-BR-A (400W, T3, 4000K) RXAR-400-3-VS-CP-BR-A (360W, T3, 4000K) 156 lm/W RXAR-400-3-VS-CP-BR-A (325W, T3, 4000K) 4000K RXAR-400-3-VS-CP-BR-A (300W, T3, 4000K) RXAR-400-4-VS-CP-BR-A (360W, T4, 4000K) 4000K RXAR-400-4-VS-CP-BR-A (325W T4 4000K) RXAR-400-4-VS-CP-BR-A (300W, T4, 4000K) RXAR-400-5-VS-CP-BR-A (400W, T5, 4000K) 400W 4000K 156 lm/W RXAR-400-5-VS-CP-BR-A (325W, T5, 4000K) 325W 4000K RXAR-400-5-VS-CP-BR-A (300W, T5, 4000K) 300W 4000K Type V 50100lm 167 lm/W Dimensions (250/300/400W

Performance Table (continued)

RXAR-300-5-VS-CP-BR-A (180W, T5, 4000K)

Specifications are subject to change without notice. Installation must be performed in accordance with Barron Lighting Group installation instructions.

10810439 Rev 10

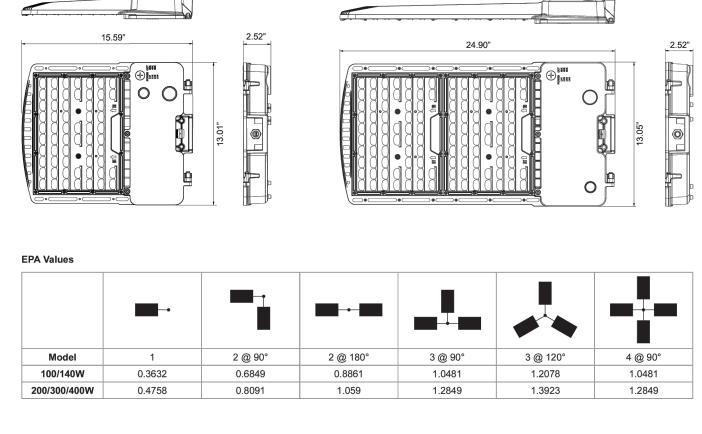

Page 4 of 7

10810439 Rev 10 Sensor Details - Bluetooth Enabled (Accessory LE-MS3W-AUX-HB1)

SENSOR SETTINGS

For a complete list of litelogic

compatible products, click here.

TL-MSP12-BL

Specifications are subject to change without notice


Installation must be performed in accordance with

Barron Lighting Group installation instructions.


10810439 Rev 10

LE-MS3W-BL-AUX-HB1 SEE APP FOR

Sensor Details (Accessories TL-MSP12-BL and TL-MSSW-REMOTE)

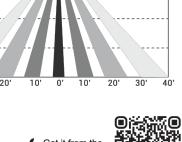

Coverage Side View

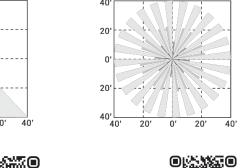







BARRON

800.533.3948 • www.barronltg.com

Coverage Top View (40')



Coverage Side View

	Coverage	Top V	iew (4	0')
30'	7/1/20		17/2	
15'				
0'				
15'				>
30' 3	30' 15'	0'	15'	30'

DETECTION RADIUS/ANGLE	MAX 60'/360°	
MOUNTING HEIGHT	MAX 40'	
REMOTE RANGE	MAX 33'	
FREQUENCY	5.8 gHz	
HIGH MODE	70%, 80%, 90%, 100% (DEFAULT 100%)	
SENSITIVITY	20%, 50%, 75%, 100% (DEFAULT 100%)	
HOLD TIME	10sec, 1min, 5min, 10min, 15min, 20min, 30min, 60min (DEFAULT 5min)	
DAYLIGHT HARVESTING	(disabled), 10Lux, 30Lux, 50Lux, 100Lux, 150Lux, 200Lux, 300Lux (DEFAULT disabled)	
STANDBY DIM SETTING	0, 10%, 20%, 30%, OFF (∞), (DEFAULT 30%)	
STANDBY TIME SETTING (TO OFF	ON (disabled), 1min, 30min, 60min (DEFAULT 30min)	TL-N

Page 5 of 7

MOTE Accessory (Sold Separately)

BARRON lighting group 800.533.3948 • www.barronlig.com	Specifications are subject to change without no Installation must be performed in accordance Barron Lighting Group installation instructions.






Page 3 of 7

157	





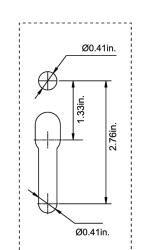

Specifications are subject to change without notice

Installation must be performed in accordance with

Barron Lighting Group installation instructions.

10810439 Rev 10

Drilling Template (Standard Mount)



Page 7 of 7





Date: Drawn By: Scale: DRAWING NO.

Project No:

11/19/24 C. Wood As Noted

D

Ë

B

0

O


D

0

Δ

BARRON

800.533.3948 • www.barronltg.com

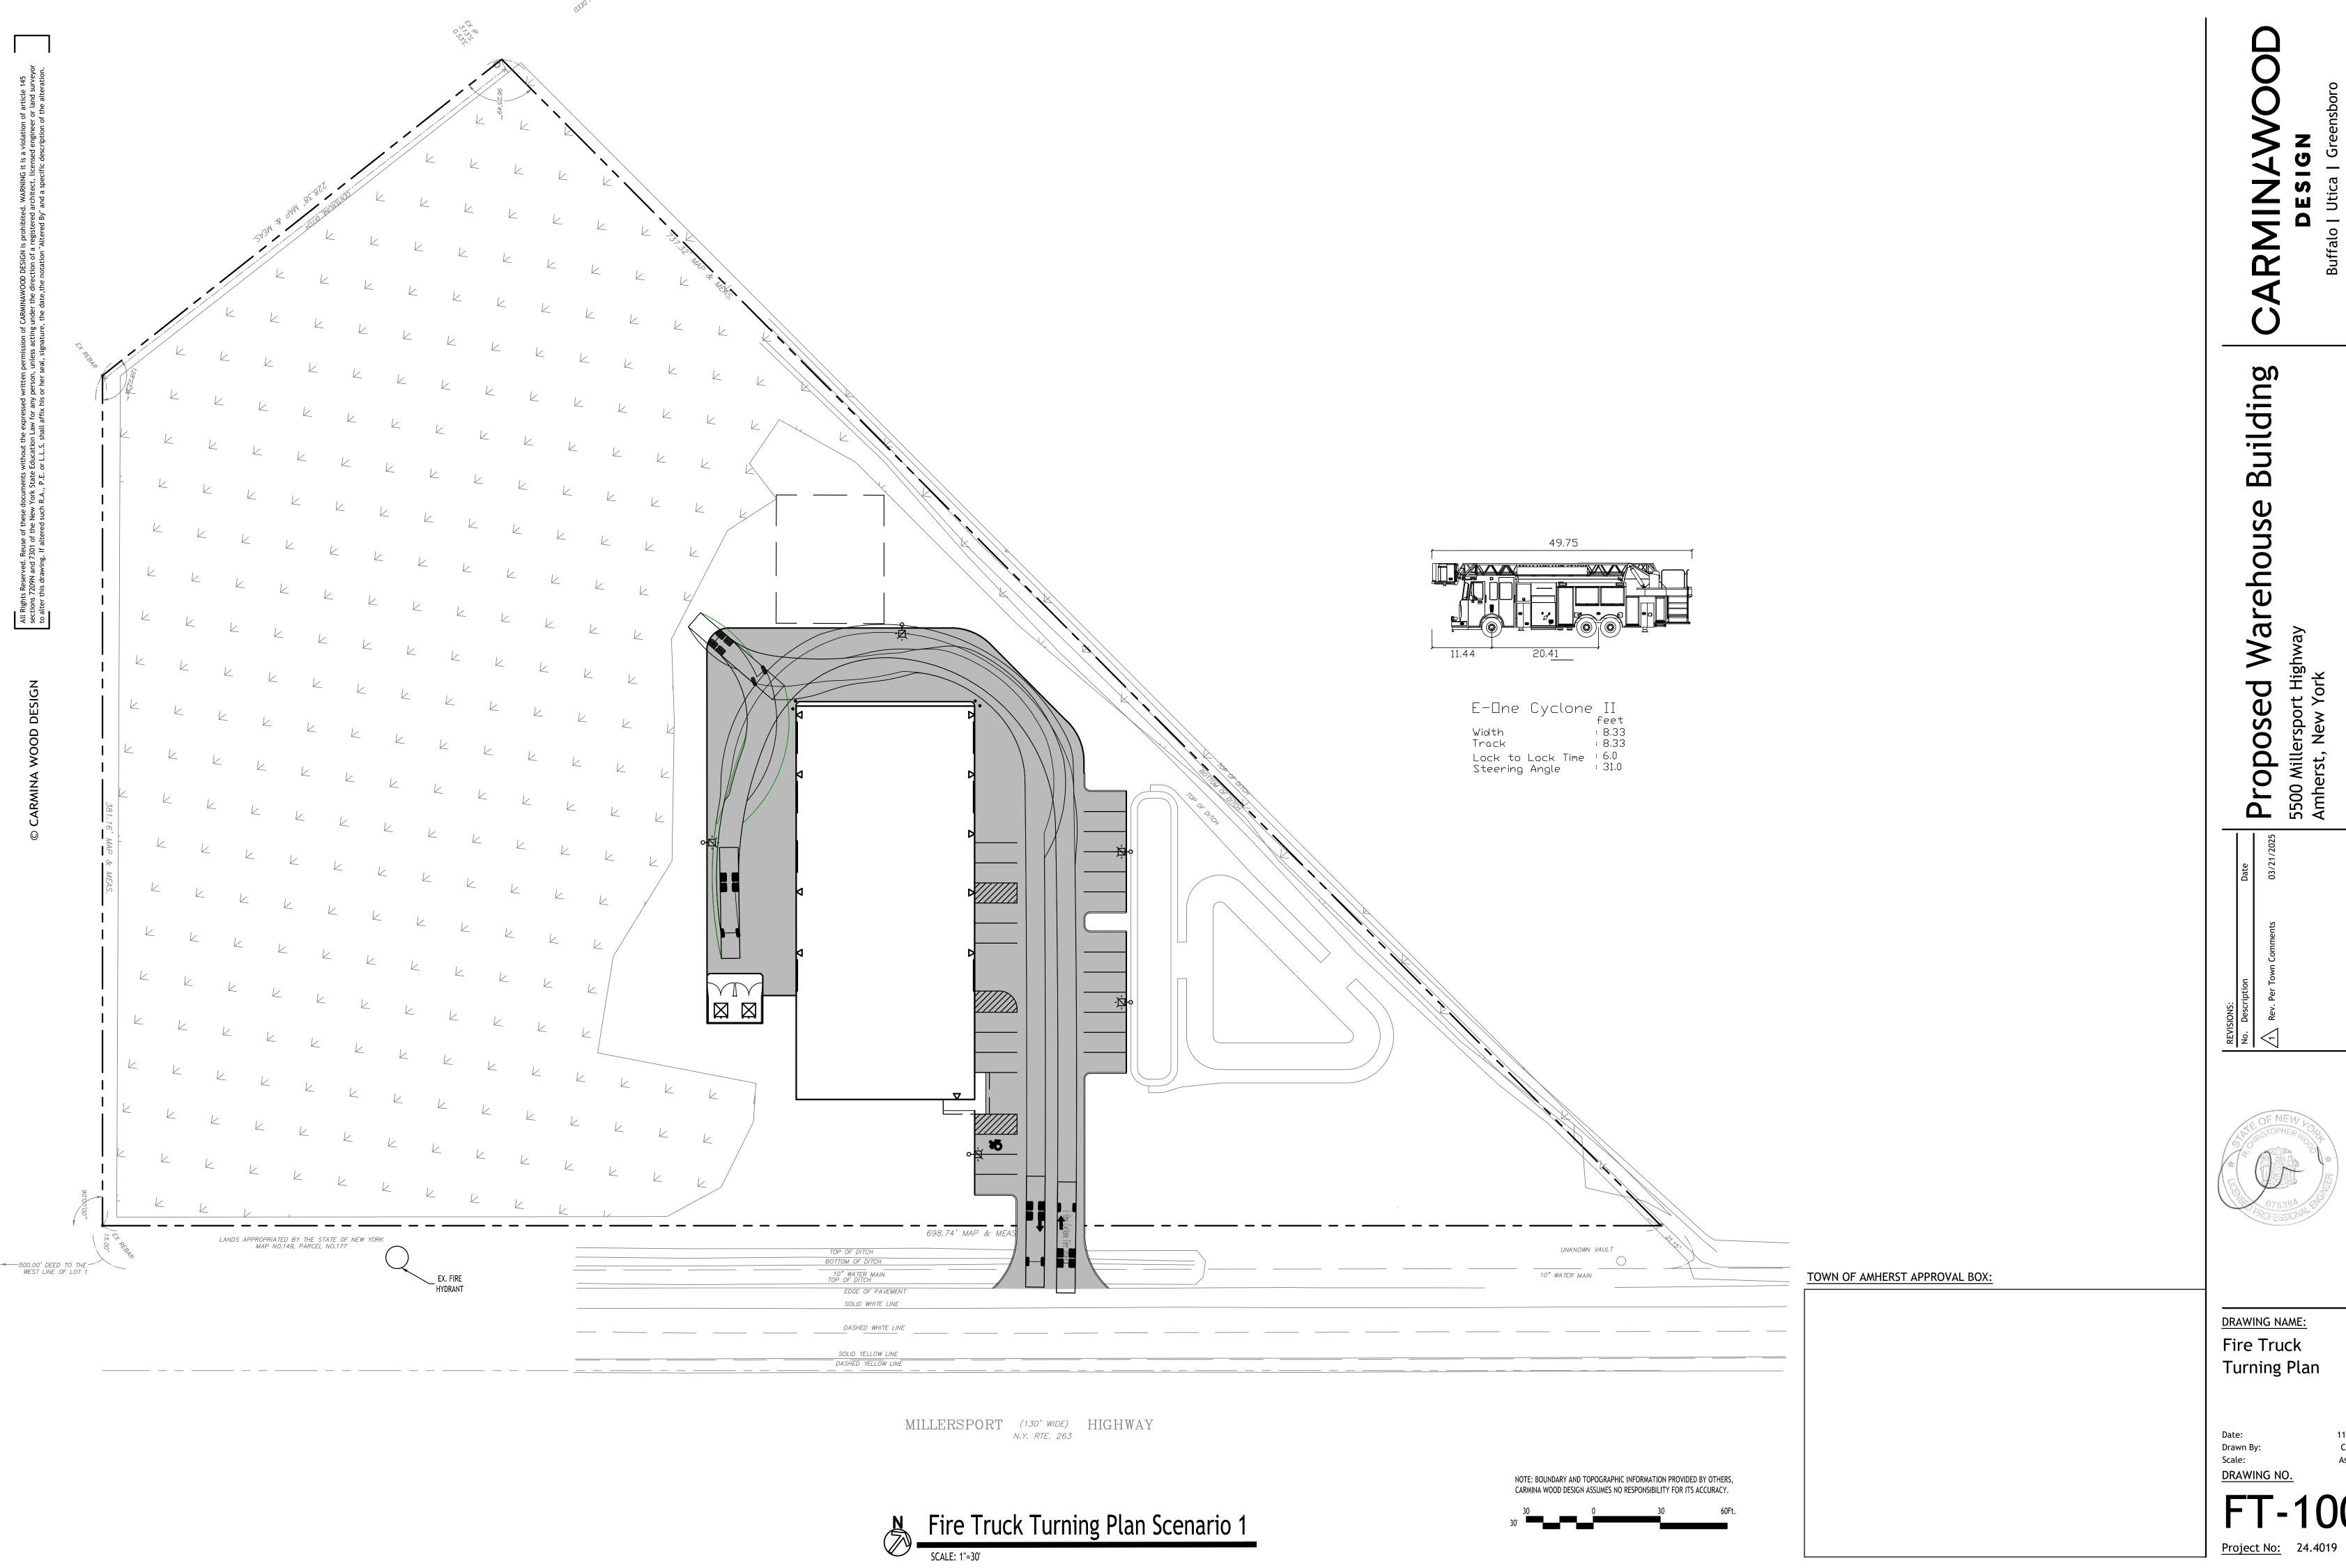

DRAWING NAME: Fire Truck

11/19/24 C. Wood As Noted